

2023-11-20

2023-11-20 Issued DP

Project Title GALLAGHERS'S CANYON DEVELOPMENT CONDO 4500-4680 GALLAGHERS DRIVE EAST



233 BERNARD AVENUE KELOWNA, B.C. VIY 6N2 TEL: 250.762.3004 EMAIL: kel-mai@shaw.ca

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Drawn Checked

A0.00







titanium OC-49



hardie - iron gray



retail facade with stone base & wood posts





Nov 20,2023

REQUIRED FIRE S	3.1.3.1.	
MAJOR OCCUPANCIES	MAJOR OCCUPANCIES	
	CONDO	
GROUP C TO C	1 HR	3.3.1.1.
GROUP F3 TO C	1.5 HR	
GROUP E TO C	2 HR	
SERVICES ROOMS	1 HR	3.6.2.
JANITOR ROOM	Non-Rated Fire Separation	

BUILDING FIRE SAFETY				
SOFFIT PROTECTION	N/A	3.2.3.16.		
FLAME SPREAD RATINGS	COMPLY WITH	3.1.13.2		
METAL DECK ASSEMBLIES	N/A	3.1.14.2.		
ROOF COVERING CLASSIFICATION	CLASS "A"	3.1.15.2.		
ATTIC FIRESTOPS	YES	3.1.11.		
MAX. ATTIC AREA	300 sm	3.1.11.5.		
MAX. CRAWLSPACE AREA	N/A	3.1.11.6.		
CONCEALED FLOOR AREA	N/A	3.1.11.5.		

ATTIC FIRESTOPS	YES	3.1.11.					
MAX. ATTIC AREA	300 sm	3.1.11.5.					
MAX. CRAWLSPACE AREA	N/A	3.1.11.6.					
CONCEALED FLOOR AREA	N/A	3.1.11.5.					
ACCESSIBILITY R	REQUIREMENTS						
	CONDO:						
	REQUIRED PROVIDED						
ACCESS TO MAIN ENTRANCES	YES	YES					
ACCESS TO ALL FLOORS	NO	YES					

NO (YES @ CRU)

WASHROOM FIXTURES REQUIREMENTS	
MIN. 1 REQ'D./ DWELLING UNIT	3.7.2.2.(11)
WASHROOM REQUIREMENTS FOR CRU TO BE CONFIRMED BY FUTURE TENANT	

NO (YES @ CRU)

ACCESSIBLE WASHROOM


CONDO SPATIA	L SEPARATION	3.2.3.1.D		
	NORTH / REAR WALL	EAST / SIDE WALL	SOUTH / FRONT WALL	
WALL AREA	±34sm	±26.3sm	window openings & walls	
OPENING AREA	±13.8 sm	±8.0 sm	construction un-restricted.  limiting distance exceeds	
% PROVIDED	±40.6%	±30.4%	7.0m (residential)	
LIMITING DISTANCE	2.9 m	4.9 m	or building faces a street in accordance with	
% PERMITTED	±41.4%	±97.8%	3.2.3.10.(2)	
CONSTRUCTION TYPE	COMBUST./NON-COMBUST.	COMBUST./NON-COMBUST.		
CLADDING MATERIAL	NON-COMBUSTIBLE	NON-COMBUSTIBLE		
REQUIRED RATINGS	45 MINUTES	45 MINUTES		

BUILDING CODE REVIEW	BCE	3C 2018		
OCCUPANCY	GROUP C	GROUP C		ROUP E
	CONDO		PARKADE / C	RU
ARTICLE	3.2.2.50		3.2.2.50.(5)	
NO. OF STOREYS	3 STOREY		3 STOREY	
NO. OF STREETS FACING	1			
BUILDING AREAS:	PROPOSED	CODE MAX.	PROPOSED	CODE MAX.
	1,498 sm	3,000 sm	1,498 sm	3,000 sm
CONSTRUCTION TYPE	COMBUST./N	L ON-COMBUST.	COMBUST./N	L ON-COMBUST.
SPRINKLERED	YES		YES	
ASSEMBLY RATINGS:				
FLOOR	1 HR		1.5 HR (2 HR	@ CRU)
WALLS / BEARING STRUCTURE	1 HR		1.5 HR (2 HR	@ CRU)
ROOFS	1 HR		1.5 HR (2 HR	@ CRU)

FIRE PROTECTION:	3.2.4./ 3.2	.5./ 3.2.6.
	CONDO	
LOCATION OF HYDRANT :	45 m MAX. TO SIAMESE CONNECTION	3.2.5.15.
STANDPIPE/HOSE	YES	3.2.5.8.
SPRINKLERED	YES (NFPA 13)	
FIRE ALARM SYSTEM	YES	3.2.4.1.(2)(f)
EXIT LIGHTS	YES	
EMERGENCY LIGHTING	YES	

OCCUPANT LOAD		TABLE 3.1.17.1.				
CONDO						
PARKADE LEVEL 0 46sm / PERSON X 1,311sm		29 PERSONS				
RESIDENTIAL						
LEVEL 1	2 PERSONS / SLEEPING RMS x 16 RMS	32 PERSONS				
LEVEL 2 2 PERSONS / SLEEPING RMS x 21 RMS		42 PERSONS				


CONDO REQUIRED EXITS	2 MIN. PER FLOOR	3.1 to 3.6
	min. 800mm door width as per 3.4.3.2.(A)	min. 1100mm stair width as per 3.4.3.2.(A)
PROVIDED	DOOR	STAIR
	6.1mm / person min. 2 doors @ 3'-0" width = 1829mm min.	8.0mm / person 2 stairs @ 3'-10" width per floor = 7'-8" (2337mm)
CONDO - BUILDING 1		
PARKADE LEVEL 0	6.1 x 29 persons = 177mm	8.0 x 29 persons = 232mm
RESID LEVEL 1	6.1 x 32 persons = 195mm	8.0 x 32 persons = 256mm
RESID LEVEL 2	6.1 x 42 persons = 256mm	8.0 x 42 persons = 336mm
RESIDENTIAL UNITS	min. 1 door @ 800mm (each unit)	36" (914mm) door @ each unit
CONDO		
EXIT THROUGH LOBBY	YES	
PANIC HARDWARE REQ'D	YES (at exterior stair & lobby doors - condo only)	3.4.6.16.(2)
EXIT EXPOSURE	ОК	3.2.3.13.
MAX. TRAVEL DISTANCE	Condo = 45m	3.4.2.5.(1)
EXIT RATINGS REQUIRED:		
STAIR SHAFTS	1 HR (1.5 HR @ Parkade)	3.4.4.1.
CORRIDORS	1 HR	3.3.2.6.(4)

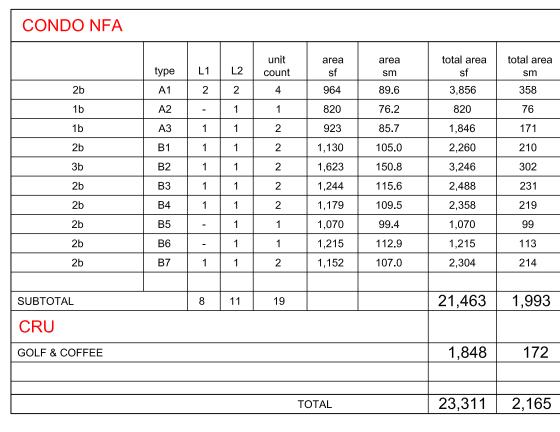

	±sf	±sm	±sf	±sm	
LEVEL 2 CRU	1,848	172			
LEVEL 2 RESID	11,835	1,100			
LEVEL 3	14,441	1,342			
SUBTOTAL	28,124	2,613			
LEVEL O PARKADE (SCOOTER RM/ STORAGE LOCKERS)			14,112	1,311	

Page 144					sm	total sr
4.0 sm per unit of comm			3 -	· 1 bed	15	45
amenity space, accessible to all residents and not located within required setback areas.  CONDO		14 -	2 bed	25	350	
		2 -	- 3 bed	25	50	
	sm					
bachelor	7.5		Su	Subtotal		445
1 bed	15.0					
1 bed or more	25.0					
		Requi	red amenity (ir	nclude comm	non amenity)	445.0
		Re	quired commo	n amenity =	4.0 sm x 19	76.0
CONDO			PRIVATE	AMENITY	COMMON	AMEN <b>I</b> T
CONDO PROVIDED			PRIVATE sf	AMENITY sm	COMMON	AMENIT sm
	ea			1		sm
PROVIDED	ea			1	sf	sm
PROVIDED Common Landscape Are	ea			1	sf	sm 1,406.3
PROVIDED Common Landscape Are LEVEL 0 bike repair / pet wash /	ea			1	sf 15,137	sm 1,406.3 63.2
PROVIDED  Common Landscape Are LEVEL 0  bike repair / pet wash / storage locker	<b>ә</b> а	LEVEL 1 balconies		1	sf 15,137 680	sm 1,406.3 63.2
PROVIDED  Common Landscape Are LEVEL 0  bike repair / pet wash / storage locker	<b>ә</b> а	LEVEL 1 balconies LEVEL 2 balconies	sf	sm	sf 15,137 680	

CONDO		
BUILDING AREA not more than 3-storey buildin	g height 3.2.	2.50
	sm	sf
Required Max. Building Area	3,000	32,291
Proposed Building 1 Footprint Area include projection of building above	1,498	±16,119

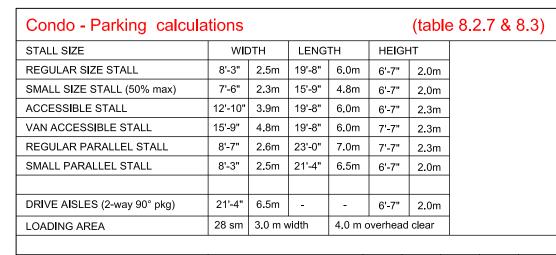

			raiking $\alpha$		min.	max.	3,52	unit	bed	unit	stall
	21,463	1,993	Loading area	bachelor	1.0	1.25	A1	4	2b	1.5	6.0
			_	1b	1.25	1.6	A2	1	1b	1.25	1.25
	1,848	172	(pg 90)	2b	1.50	2.0	A3	2	1b	1.25	2.5
	1,040	172		3b or bigge	r 2.0	2.50	B1	2	2b	1.5	3.0
							B2	2	3b	2.0	4.0
_	23,311	2,165					В3	2	2b	1.5	3.0
	,						B4	2	2b	1.5	3.0
							B5	1	2b	1.5	1.5
							В6	1	2b	1.5	1.5
±sf	±sm						В7	2	2b	1.5	3.0
				Subtotal				19			28.75
				VISITO	R						
				visitor - 0.1	4 / unit		19 unit	x 0.14			
				Required \	/isitor						2.7
				CRU							
				Required C	CRU		sf	sm			
				GFA less th		sm	1,848	172			3.4
14,112	1,311			2 spaces p	er roosm						
			TOTAL REQUIRED								34.85
			Provided	Parkade Full	Grade Full	НС	Grade HC Van	Grade Visitor	s	SUBTOT	AL
14.11 (pg	g 155)			3	-	-	1	3			

TOTAL PROVIDED

CRU Loading area (Table 8.4)

Parking &

			<u> </u>	•					
Required 1 per 1,900 sm GFA									
Provid	ded		1	(size: 30' 0" x	10' 0")				
BICY	CLE P	ARKIN	IG				8.	5 (pg	97)
REQUIF	RED LONG	TERM				width	n	length	
TYPE	#UN <b>I</b> T	#BED	#BIKE	REQUIRED	BIKE SIZE STALL	24"	0.6m	72"	1.8m
				BIKE	LONG TERM	bachelo	r, 1b, 2b	= 0.75	
						3b = 1.0			
A1	4	2b	0.75	3.00	SHORT TERM	6 per en	trance		
A2	1	1b	0.75	0.75					
А3	2	1b	0.75	1.50	PROVIDED LONG TERM				
B1	2	2b	0.75	1.50	wall mount bike in front of car			-	
B2	2	3b	1.00	2.00	ground anchored rack (bylaw 8.5.6)			15	5
В3	2	2b	0.75	1.50					
В4	2	2b	0.75	1.50	Total			15	5
B5	1	2b	0.75	0.75	PROVIDED SHORT	TERM		6	3
В6	1	2b	0.75	0.75	(1 ENTRANCE)				
В7	2	2b	0.75	1.50					
	CRI	J (0.2 per	100sm GFA)	0.35					
TOTAL			15.10						
		TOTAL	. REQU <b>I</b> RED	15.0					

EAST (GALLAGHER PINNACLE WAY)

Min rear yard setback

Min common and

RESIDENTIAL LONG TERM

RESIDENTIAL SHORT TERM

Condo footprint (L0+L1)

NUMBER OF LOADING SPACES

Condo - Site Coverage of all bldgs

private amenity space

le 8.2			ZONING SUM					
+			GALLAGHERS DRIVE	E				
			ADDRESS	4500 - 4680 GALLAGH	ERS DRI	VE EAST		
			LEGAL DESCRIPTION	LOT G PLAN KAP5311	PART OF LOT A & AN UNDIVIDED 1/24th SHARE IN LOT G PLAN KAP53116 SECTIONS 1 & 12 TOWNSHIP 26 ODYD PLAN KAP66064			
1			DEVELOPMENT PERMIT AREA	YES				
1			EXISTING ZONING	P3 - PARKS & OPEN S	PACE			
1			PROPOSED ZONING	MF3 - APARTMENT HC	USING			
1			EXISTING LEGAL USE	SINGLE FAMILY RESID	DENCE			
1			GRADES	EXISTING AVERAGE -	SLOPE			
	-4-11	1.1	NUMBER OF NEW BUILDINGS	ONE				
bed	stall per unit	stall	MF3 - APARTMENT H	OUSING				
2b 1b	1.5 1.25	6.0 1.25	CRITERIA	REQUIRED		PROVIDED		
1b	1.25	2.5	MININUM LOT WIDTH	30.0m		±90.5m		
2b	1.5	3.0	MANAGOR EST WIDTH	00.011		200.011		
3b	2.0	4.0	MININUM LOT DEPTH	30,0m		±60,8m		
2b	1.5	3.0	MININUM LOT AREA	1,400sm		±55,043sf		
2b	1.5	3.0		,		±5,114sm		
2b	1.5	1.5	MAXIMUM LOT AREA	N.A.		N.A.		
2b	1.5	1.5	Table 8.3	CONDO	28.8	35.0		
2b	1.5	3.0		VISITOR	2.7			
		28.75	off-street parking	CRU	3.4			
				TOTAL	34.8			
		0.7						
		2.7						
			Coverage	max site coverage of all buildings = 65%		28.2%		
		3.4		max site coverage of all buildings, structures and impermeable surface = 85%	es	40.5%		
	1	34.85	Max. density	max base FAR = 1.3		2,164 sm / site area = 0.42		
	Max. height		Max. height	max. base height 18m & 4 storeys				
	35.0		Min front yard and flanking side yard setback SOUTH (GALLAGHERS DRIVE E)	4.5m		condo = +/-4.91m		
	35.0	)	Min building stepback from front yard and flanking side yard	3.0m		N.A.		
			Min side yard setback	3.0m		+/-8.33m		
			W/507 (00) 5 00: 100					
8.	5 (pg	97)	WEST (GOLF COURSE)	4.5m		+/-9,03m		
n length			Min flanking side yard	4.5m	-r.om			

		±28.2%
oldgs, structures	and	85%
sf	sm	
15,500	1,440	
6,782	630	
22,282	2,070	
		±40.5%
	sf 15,500 6,782	15,500 1,440 6,782 630

private amenity = 445sm

15,500

6.0

N.A.

2023-11-20

Revision Date 2023-11-20 Issued DP GALLAGHERS'S CANYON DEVELOPMENT 4500-4680 GALLAGHERS DRIVE EAST



Consultant Seal

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Checked

**ZONING & CODE SUMMARY** 

Drawing Number

ALL DIMENSIONS SHALL BE VERIFIED ON JOB

DVP VARIANCE

(include 76sm common amenity) resid. amenity = 311sm


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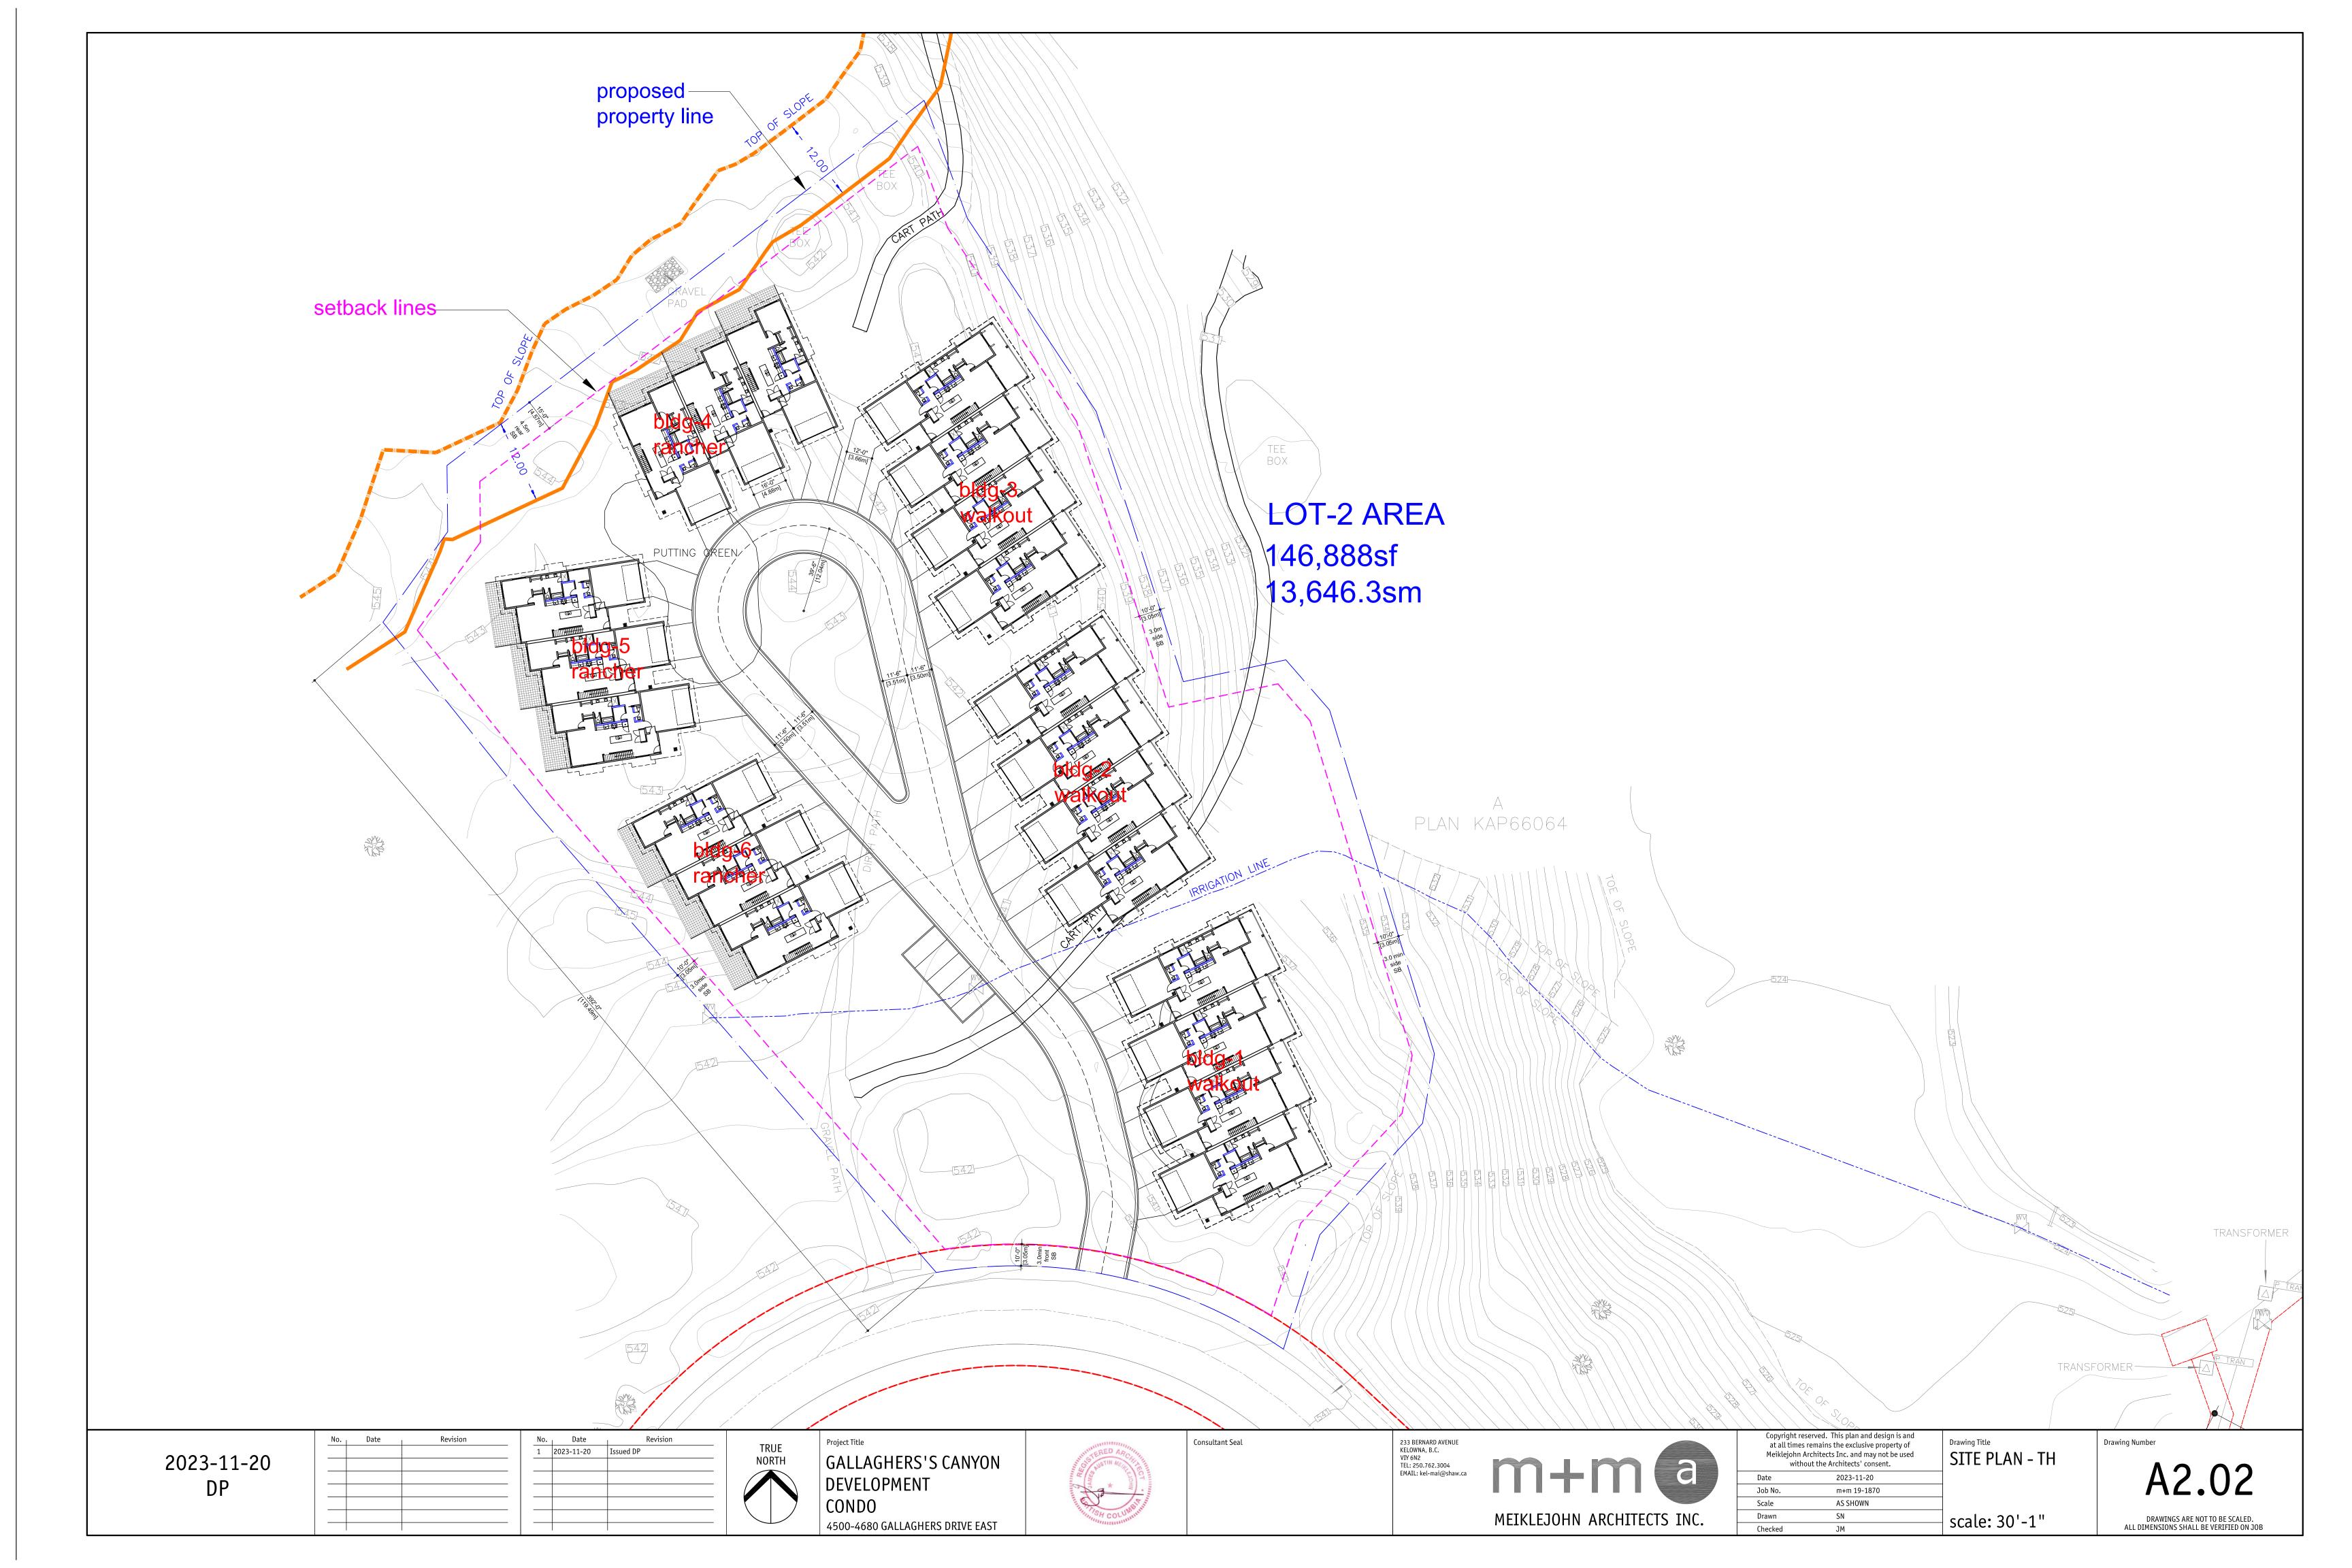
6.0


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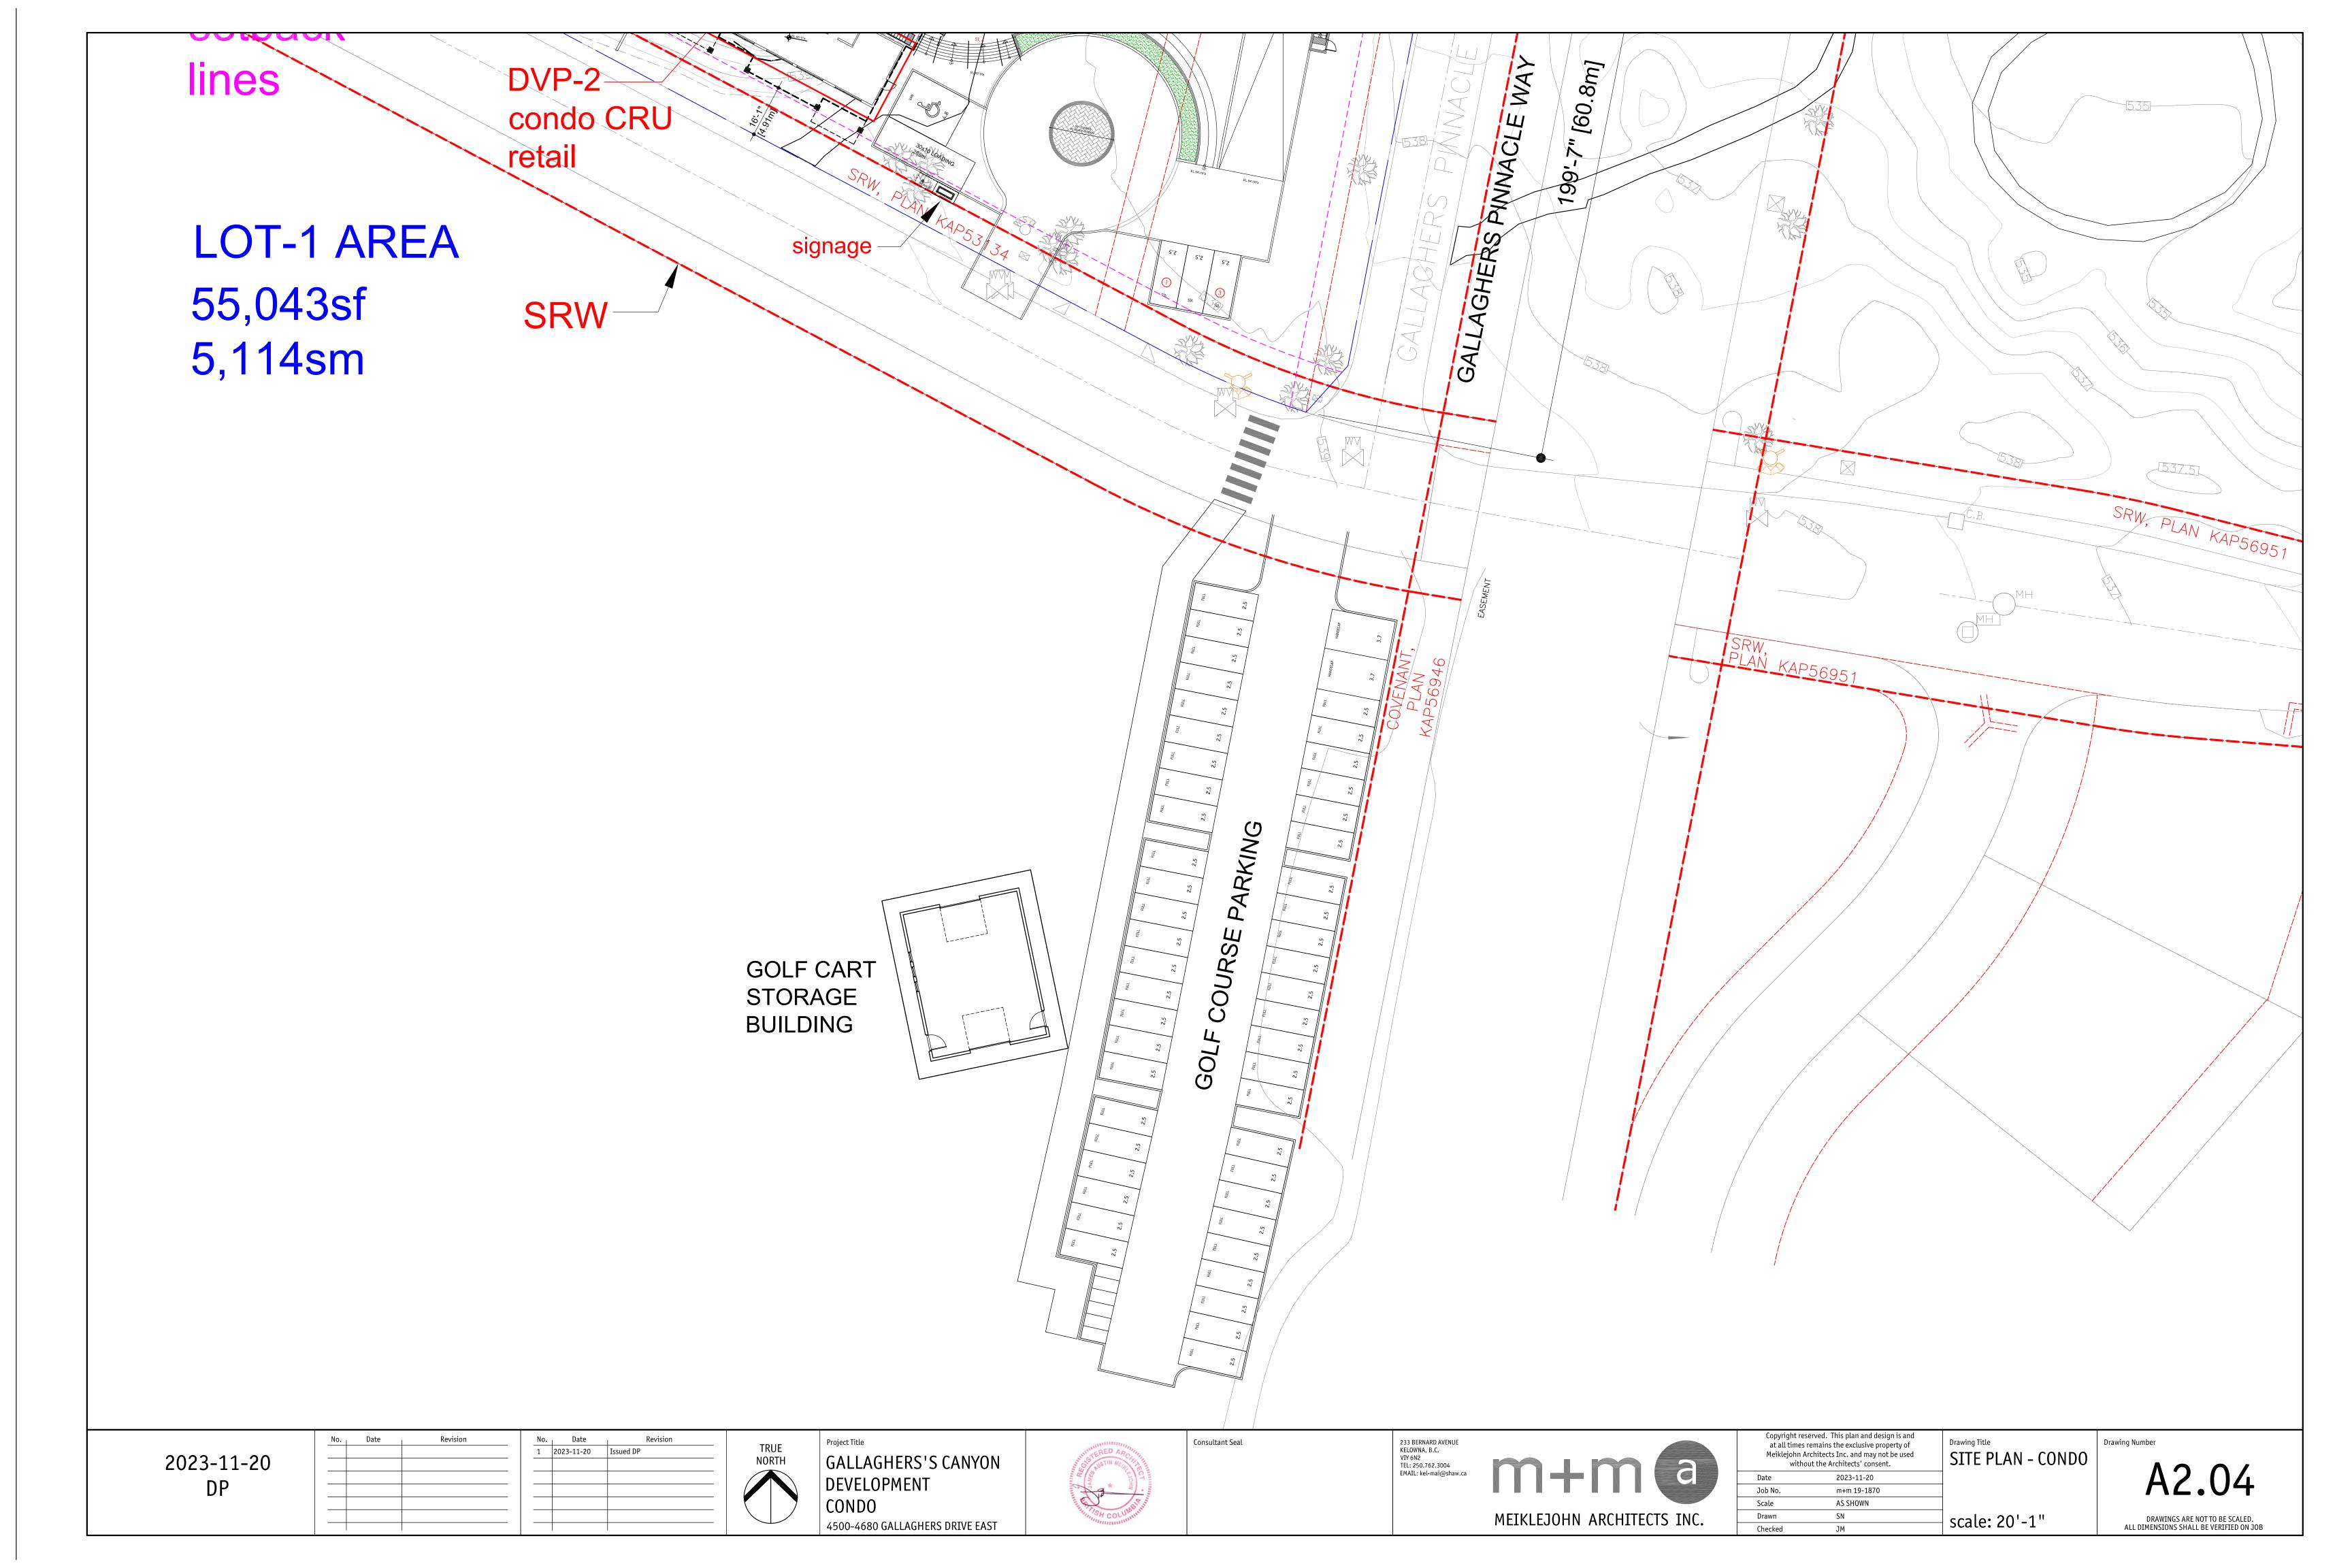
sm


1,440






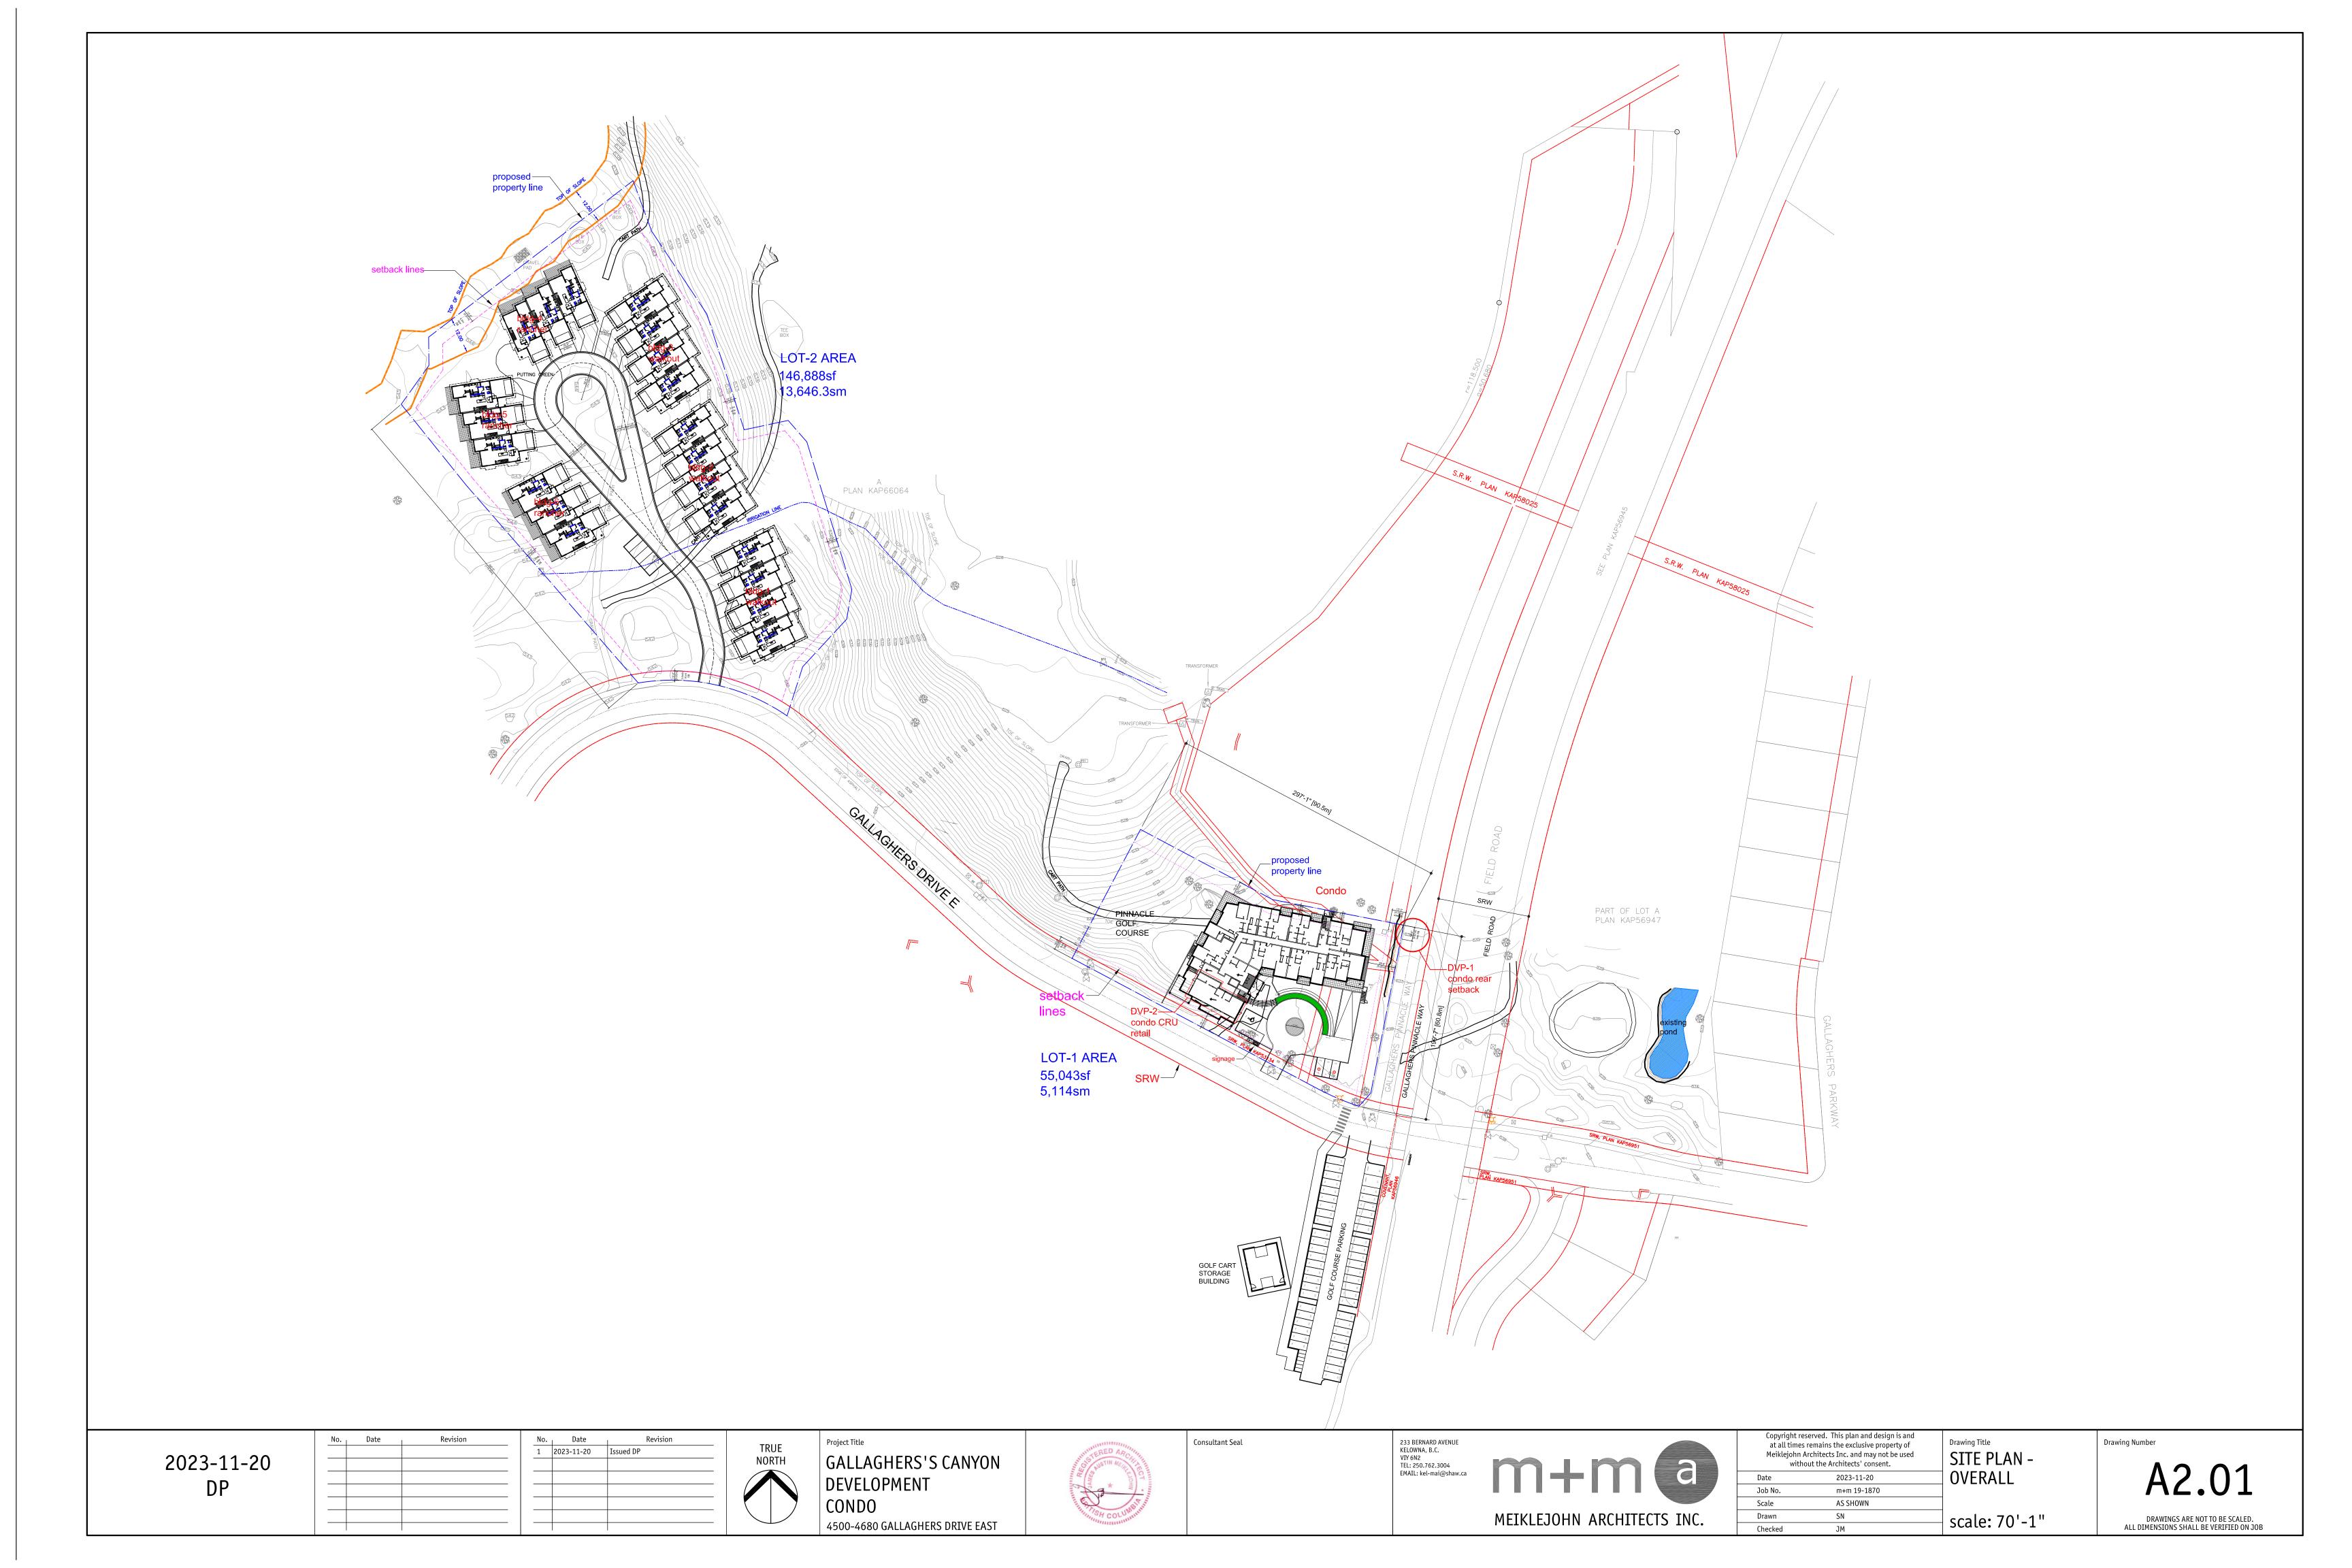


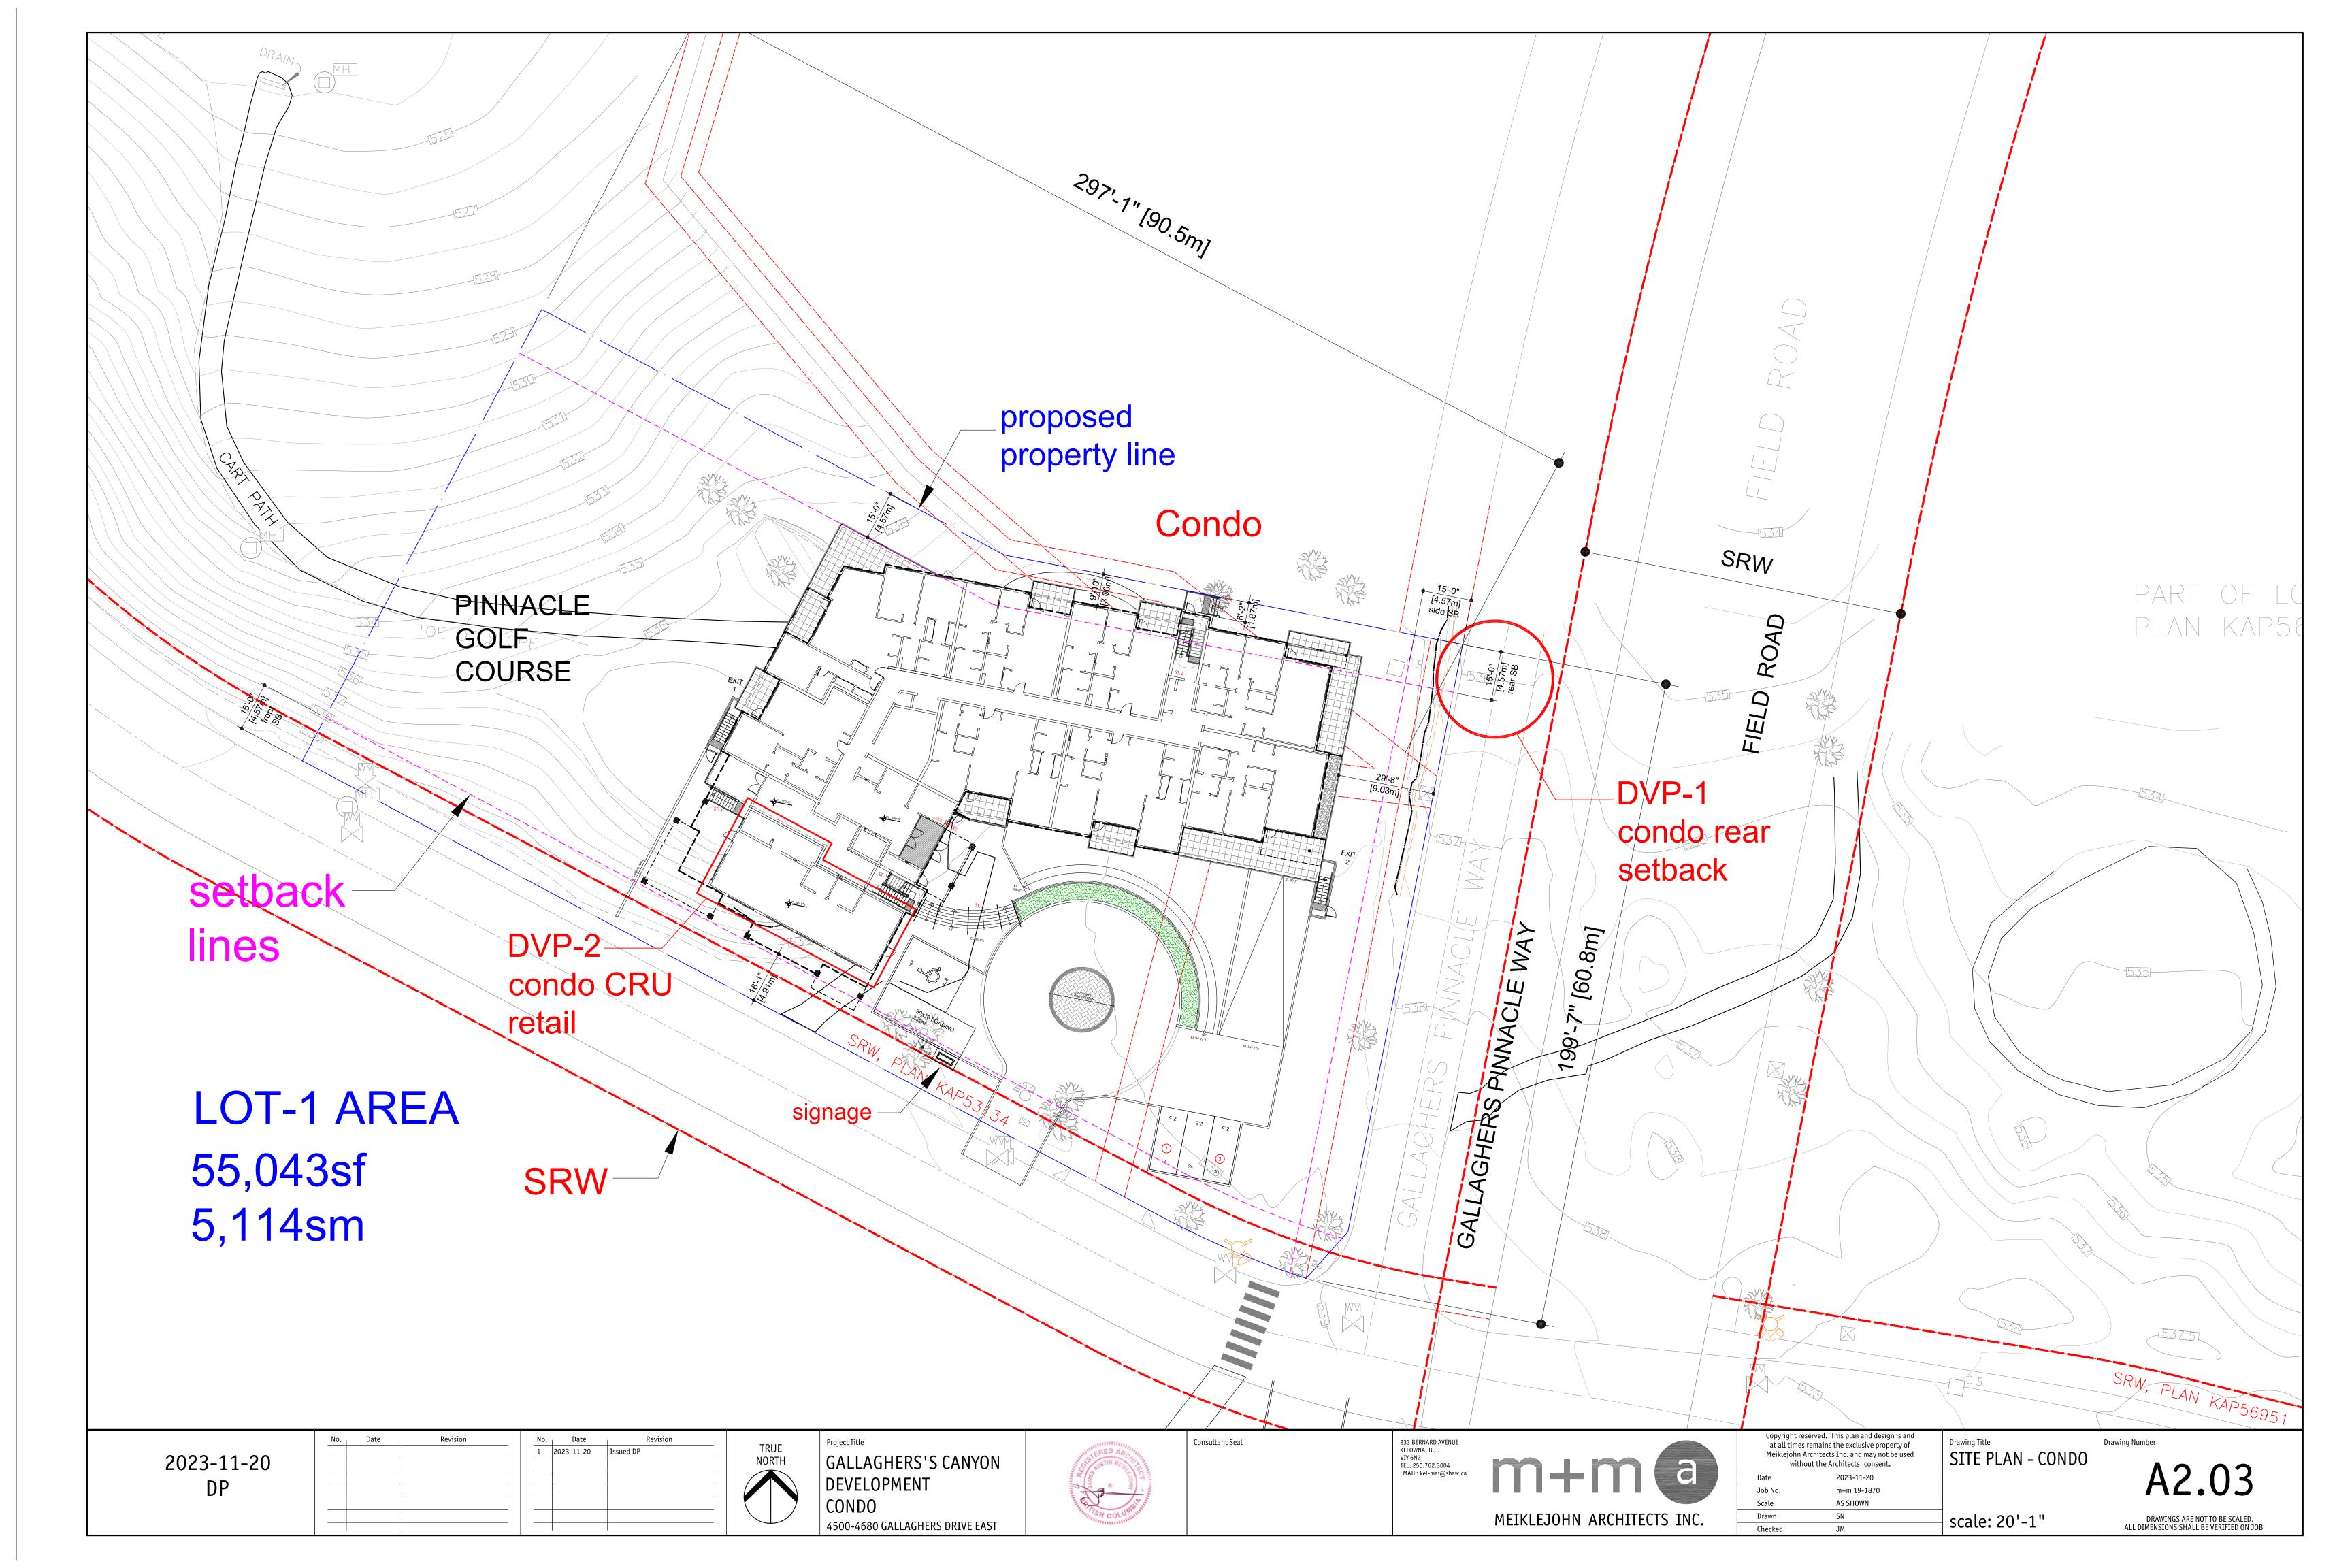


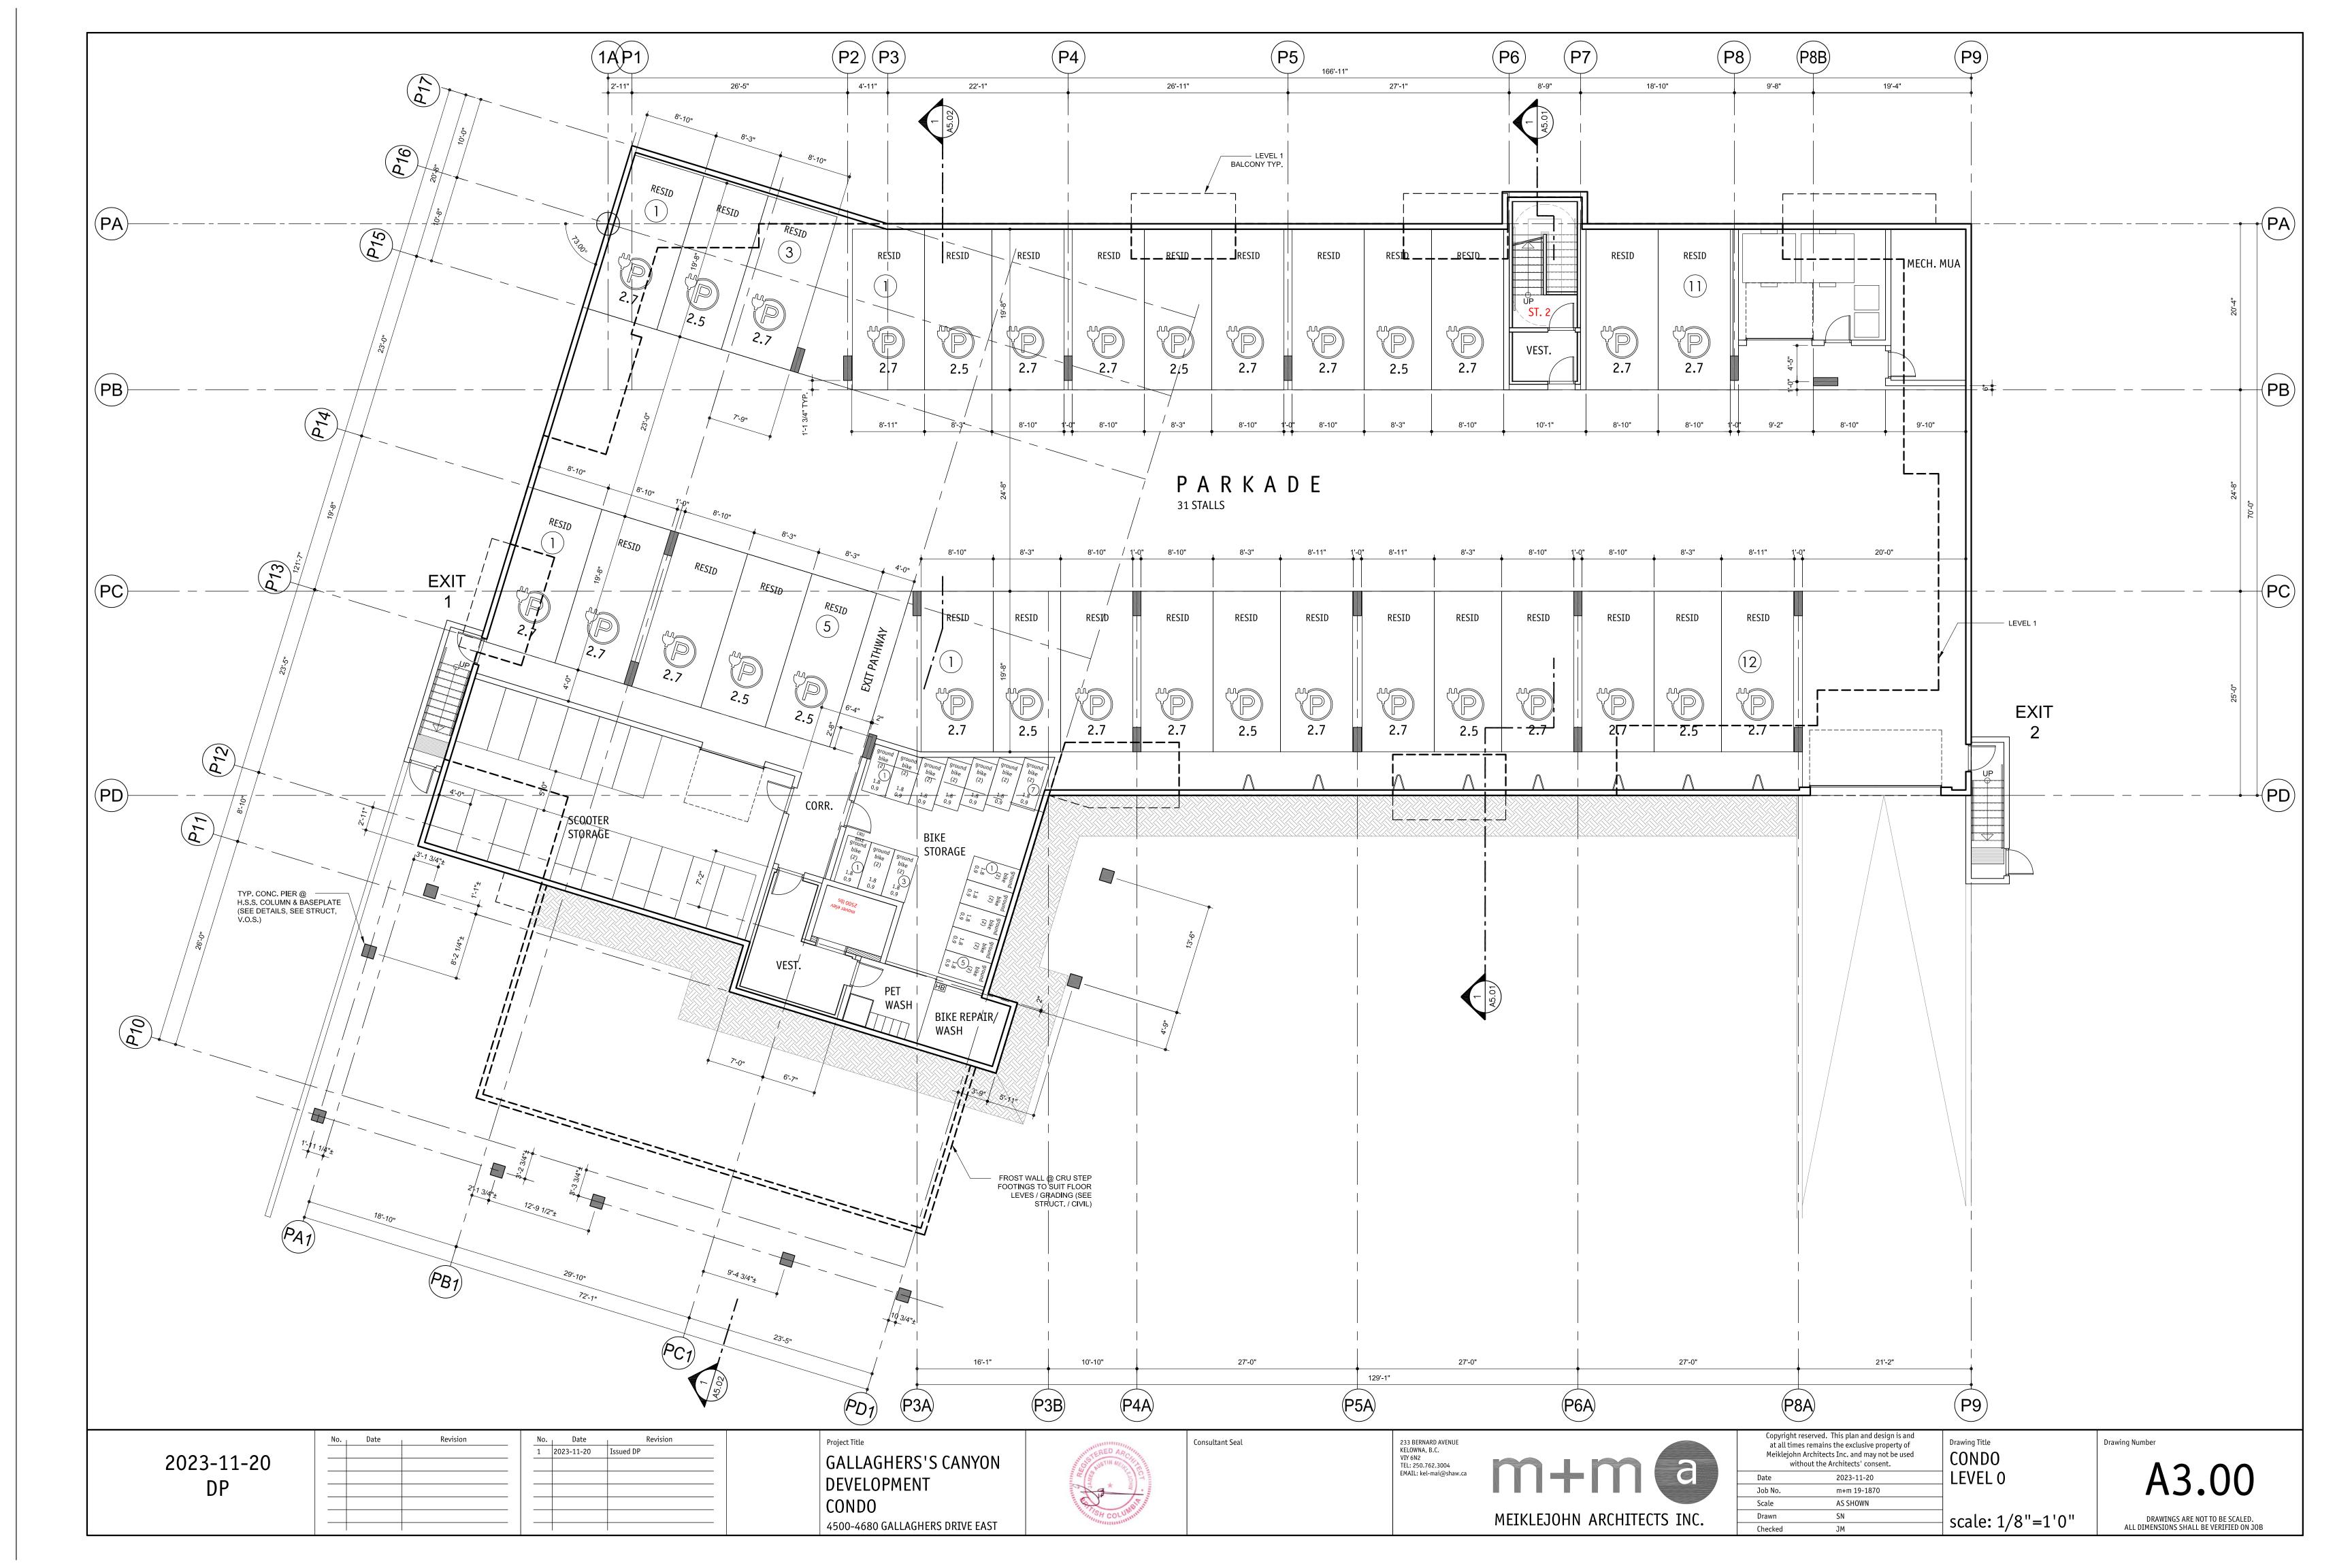


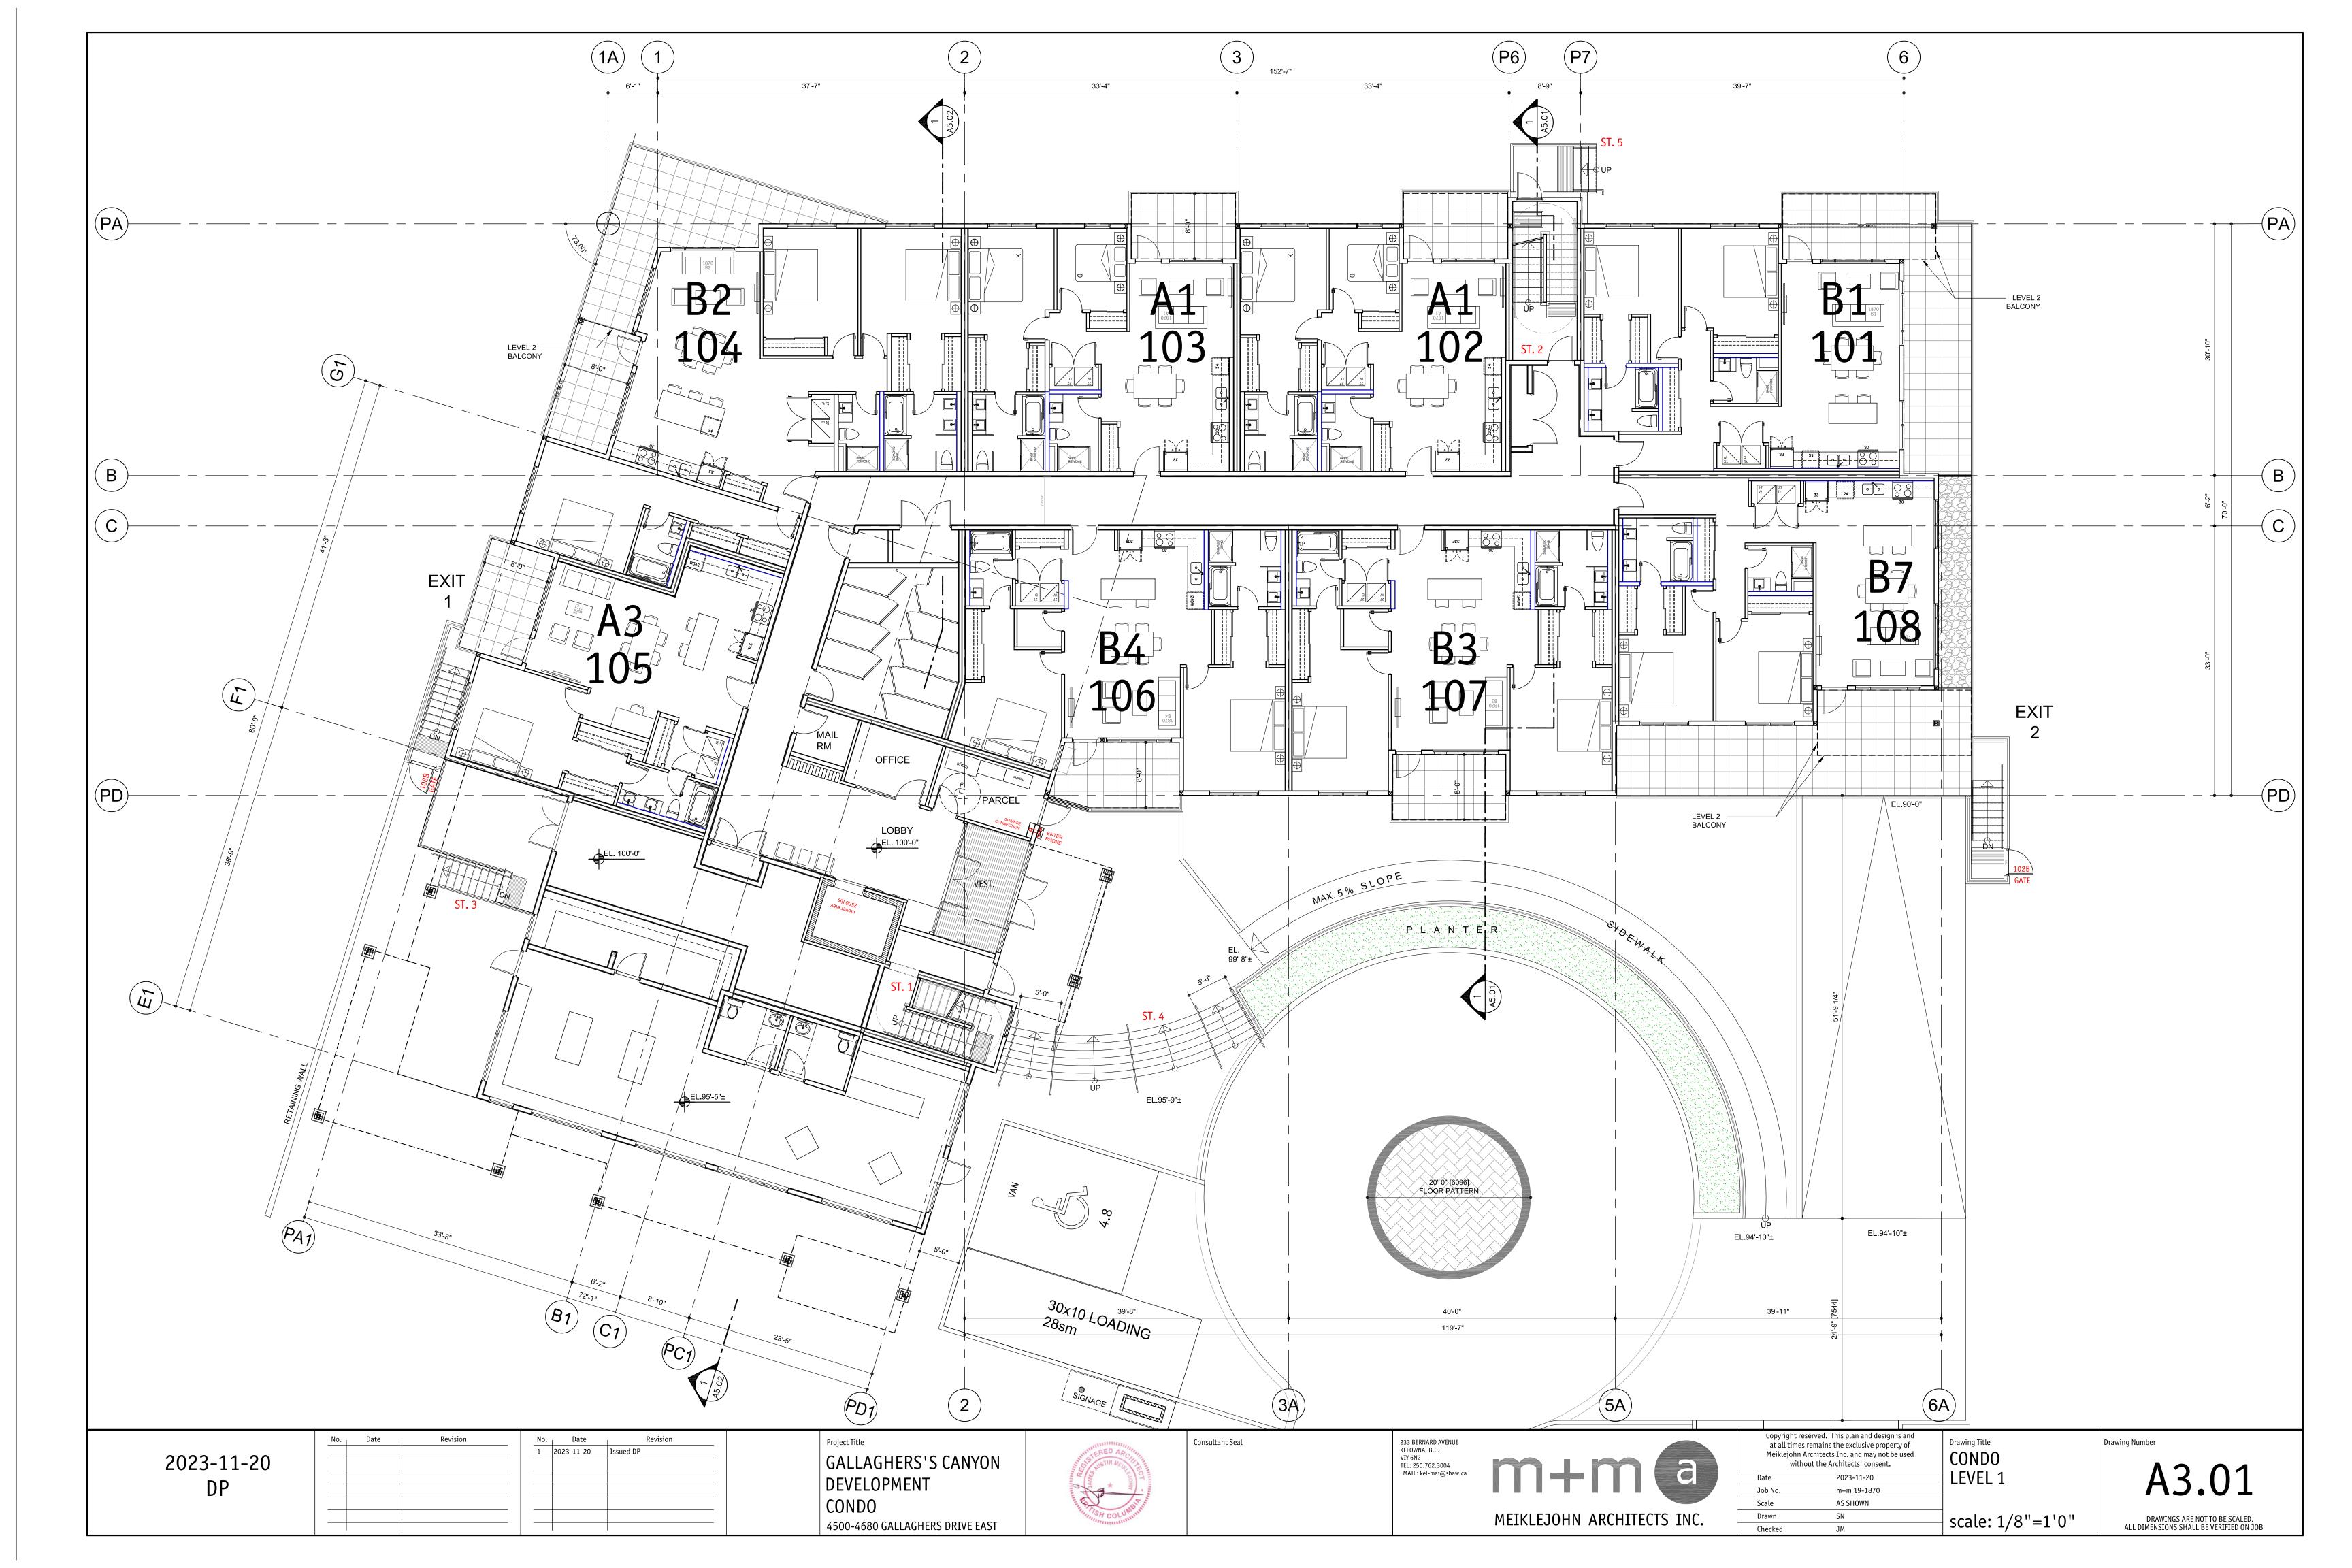



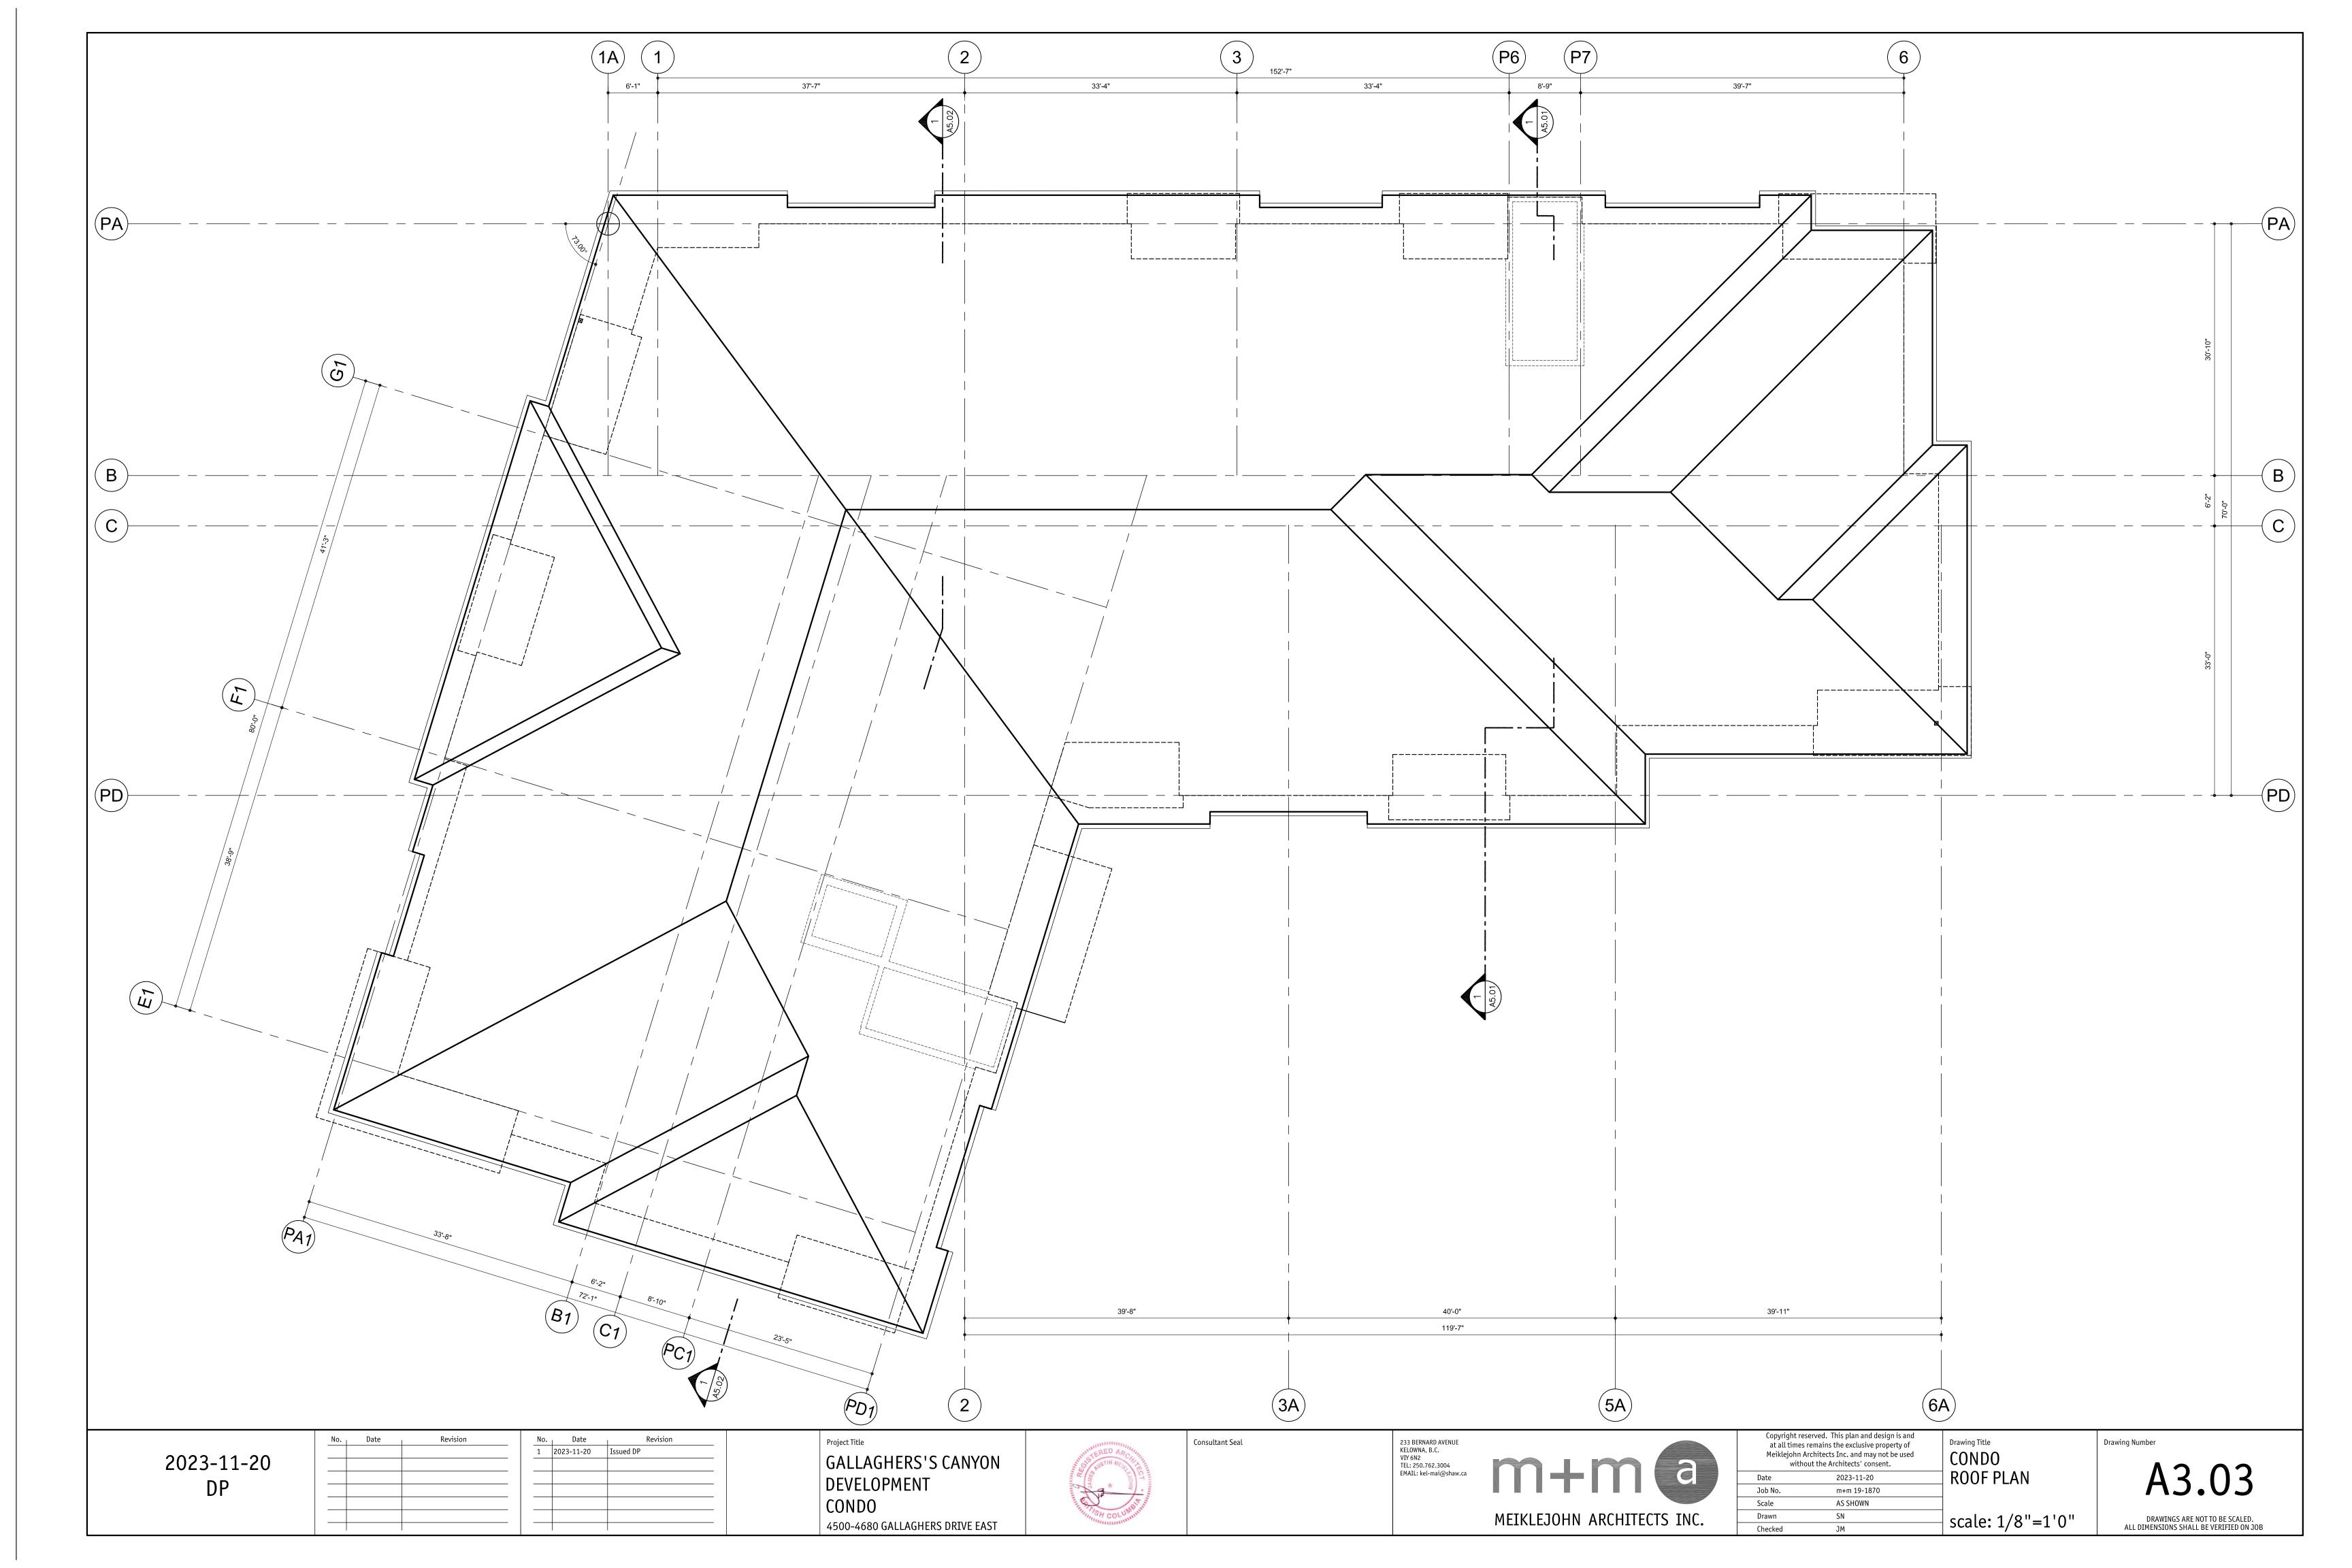

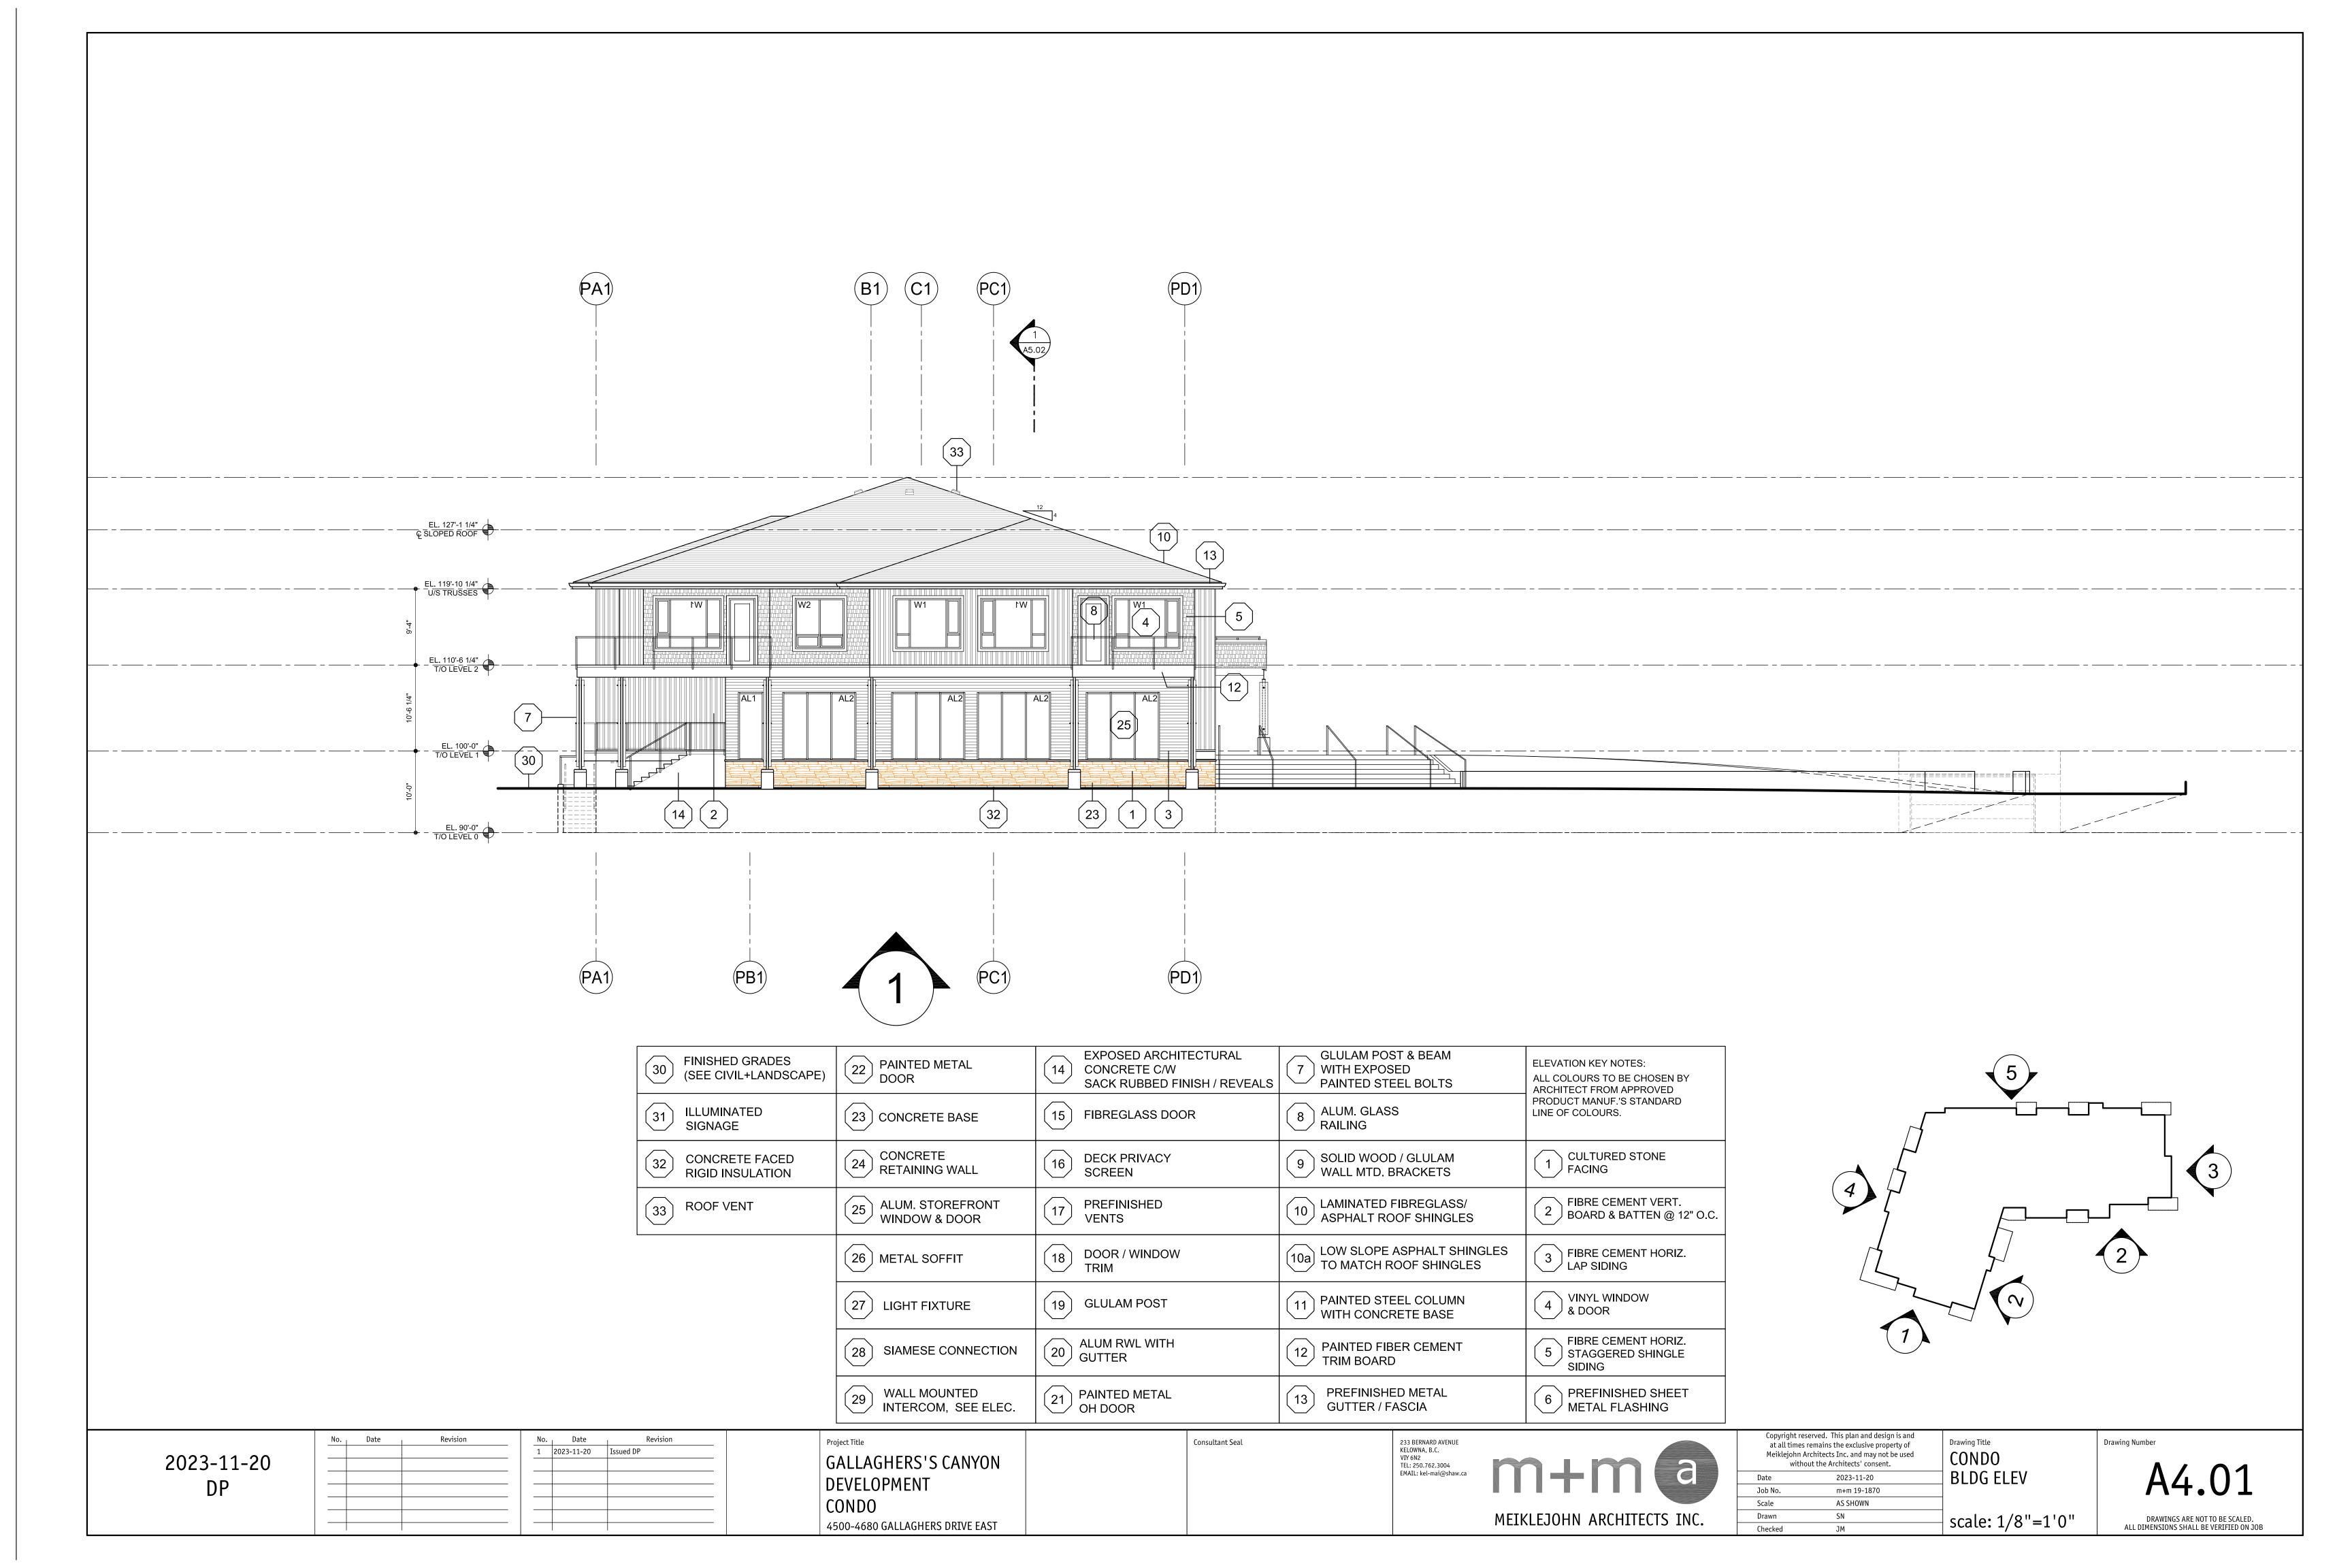

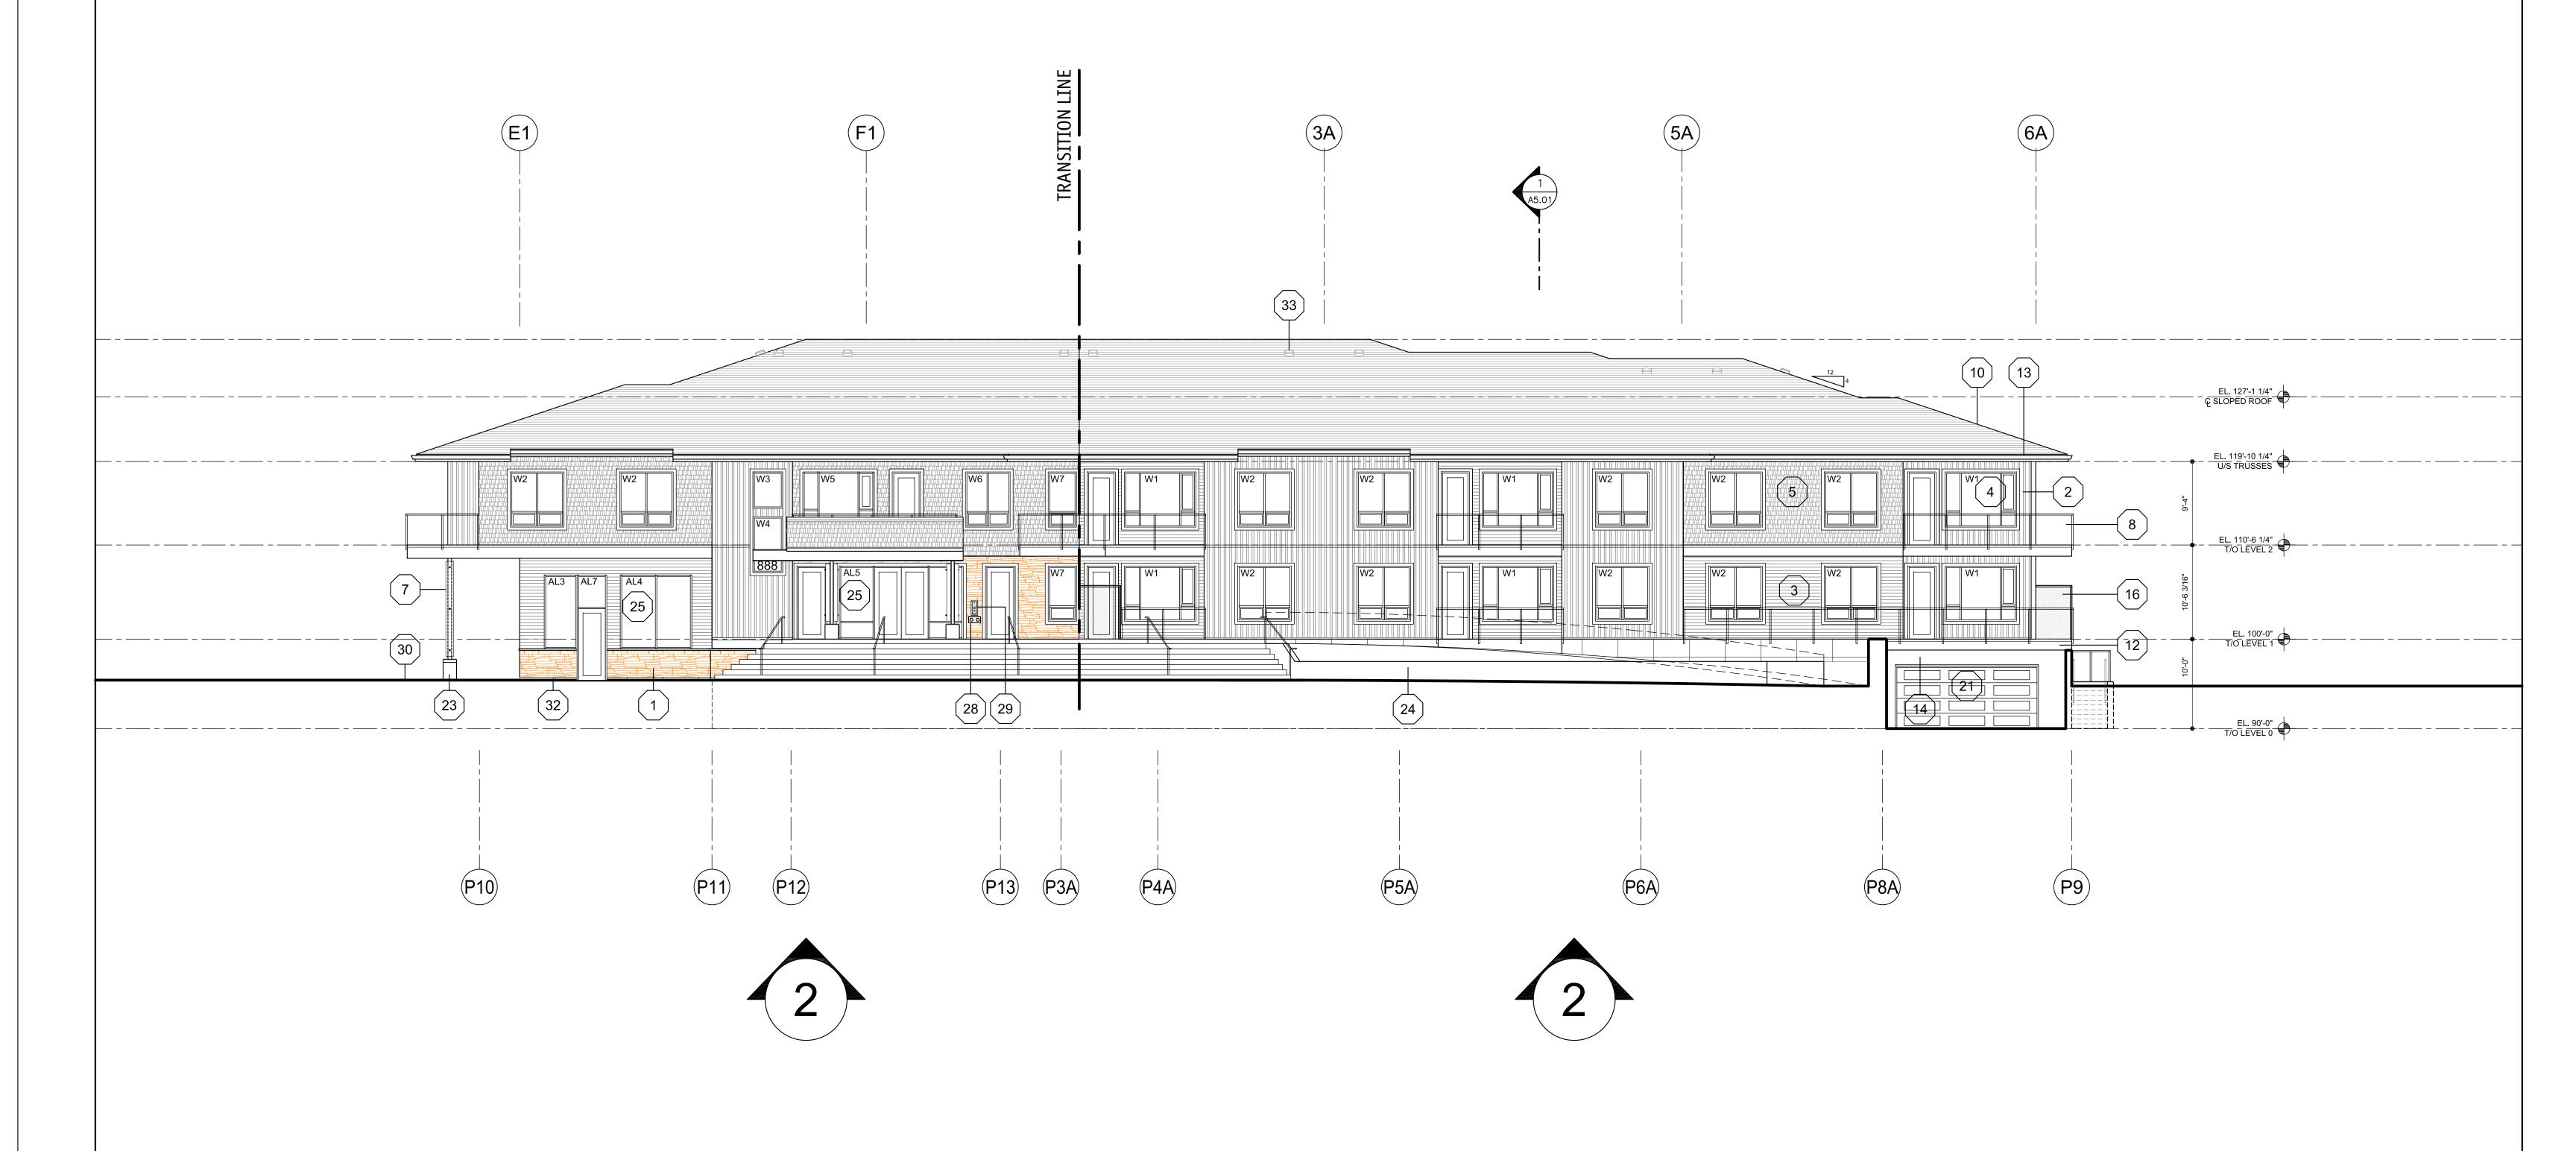

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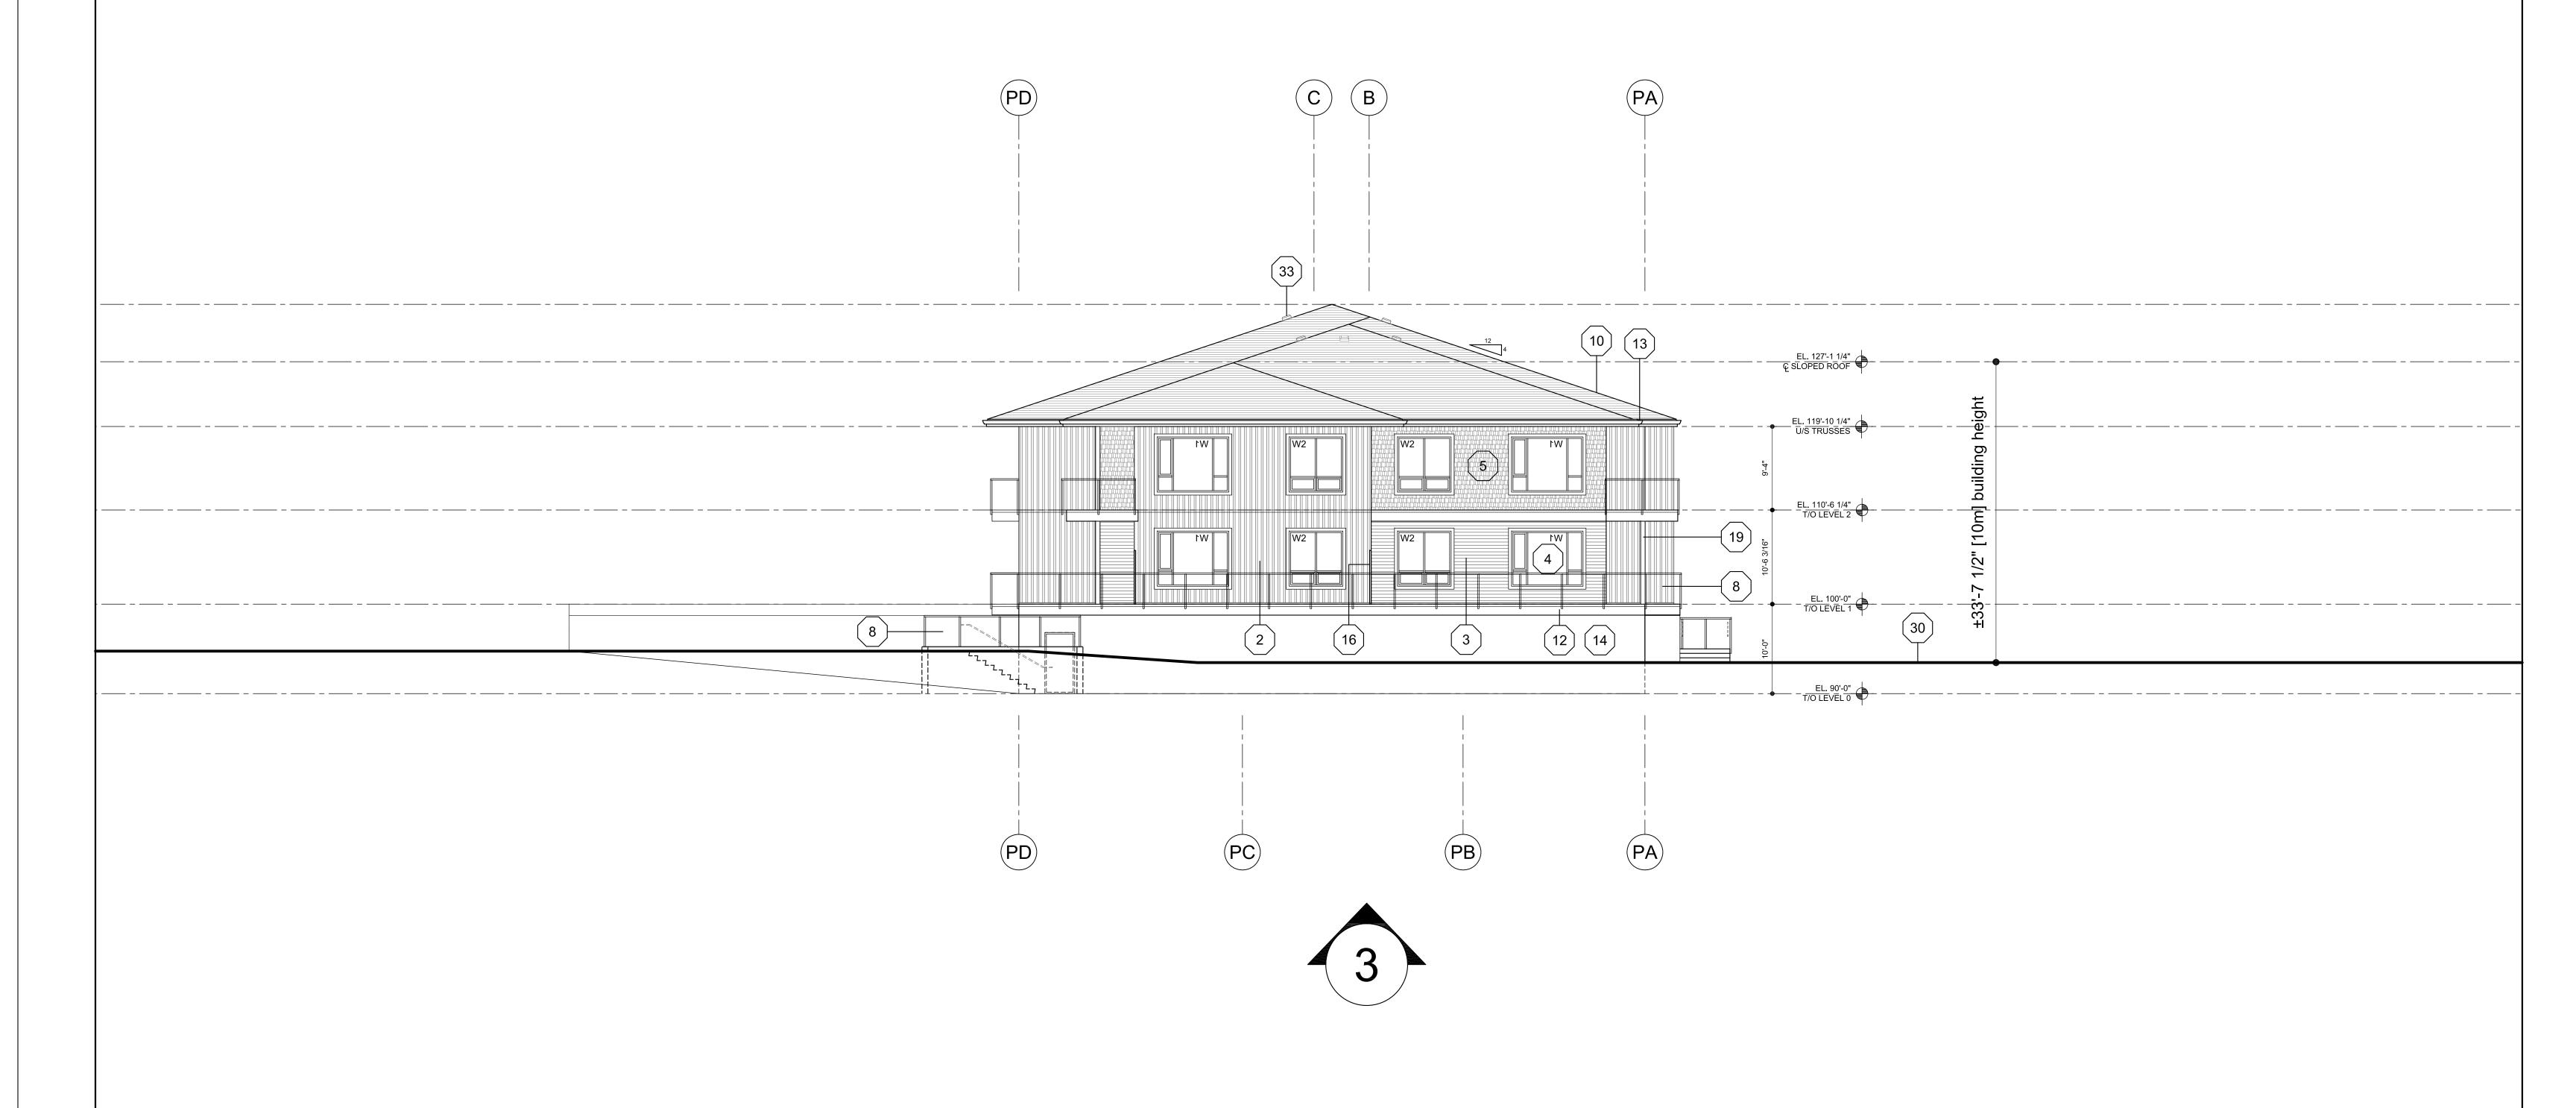
Revision

Date 1 2023-11-20 Issued DP GALLAGHERS'S CANYON DEVELOPMENT CONDO 4500-4680 GALLAGHERS DRIVE EAST

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Drawing Number BLDG ELEV scale: 1/8"=1'0"



2023-11-20 DP Revision No. Date Revision

1 2023-11-20 Issued DP

GALLAGHERS'S CANYON
DEVELOPMENT
CONDO
4500-4680 GALLAGHERS DRIVE EAST

233 BERNARD AVENUE
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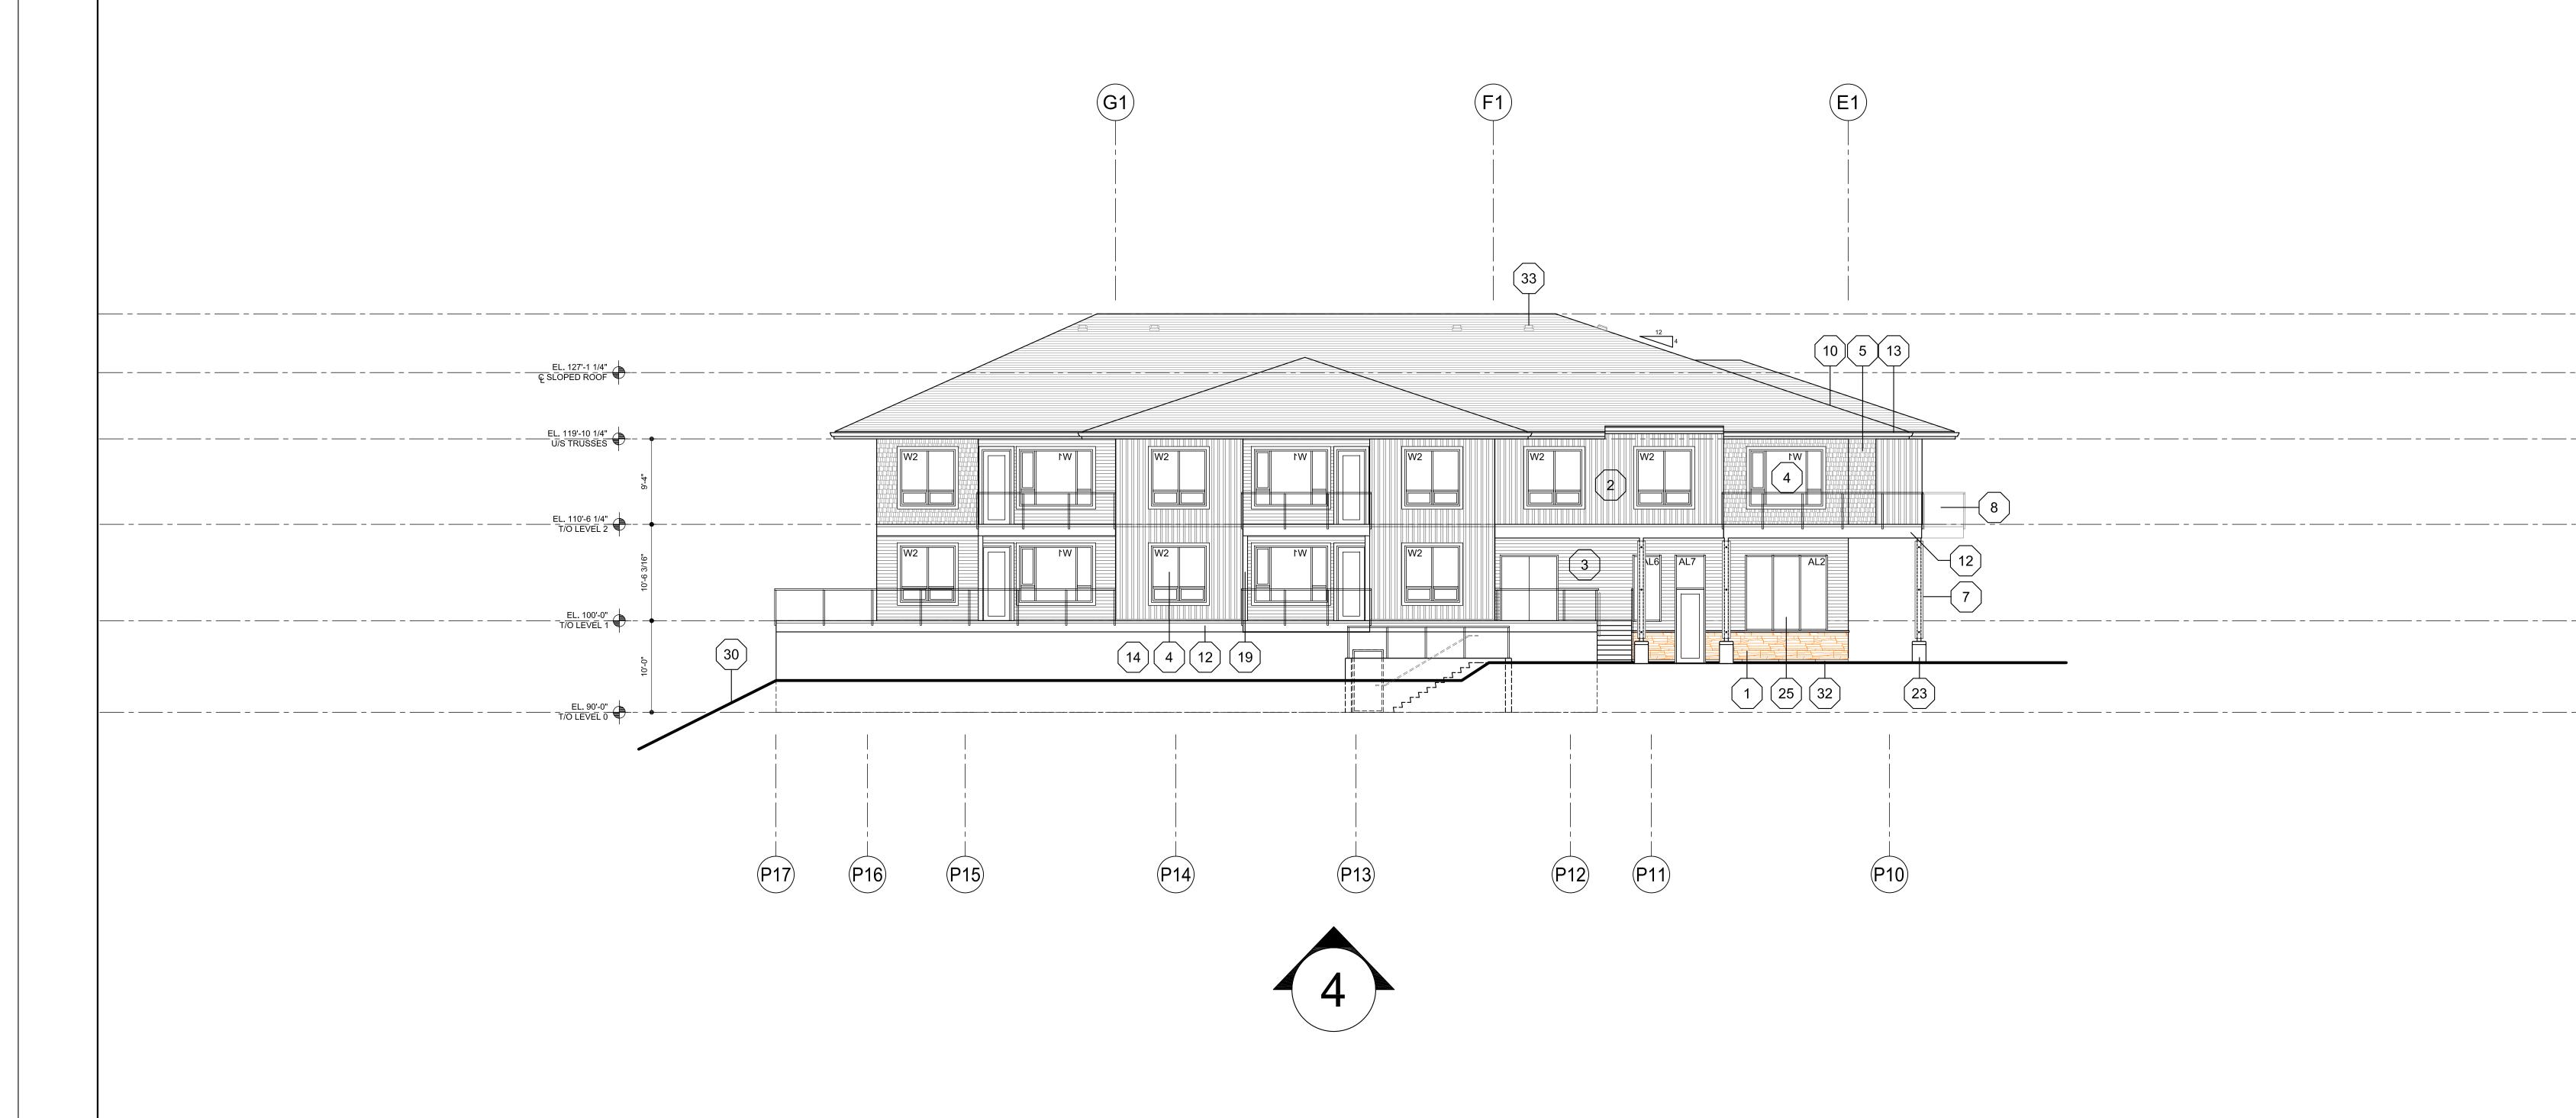
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GALLAGHERS'S CANYON
DEVELOPMENT
CONDO
4500-4680 GALLAGHERS DRIVE EAST

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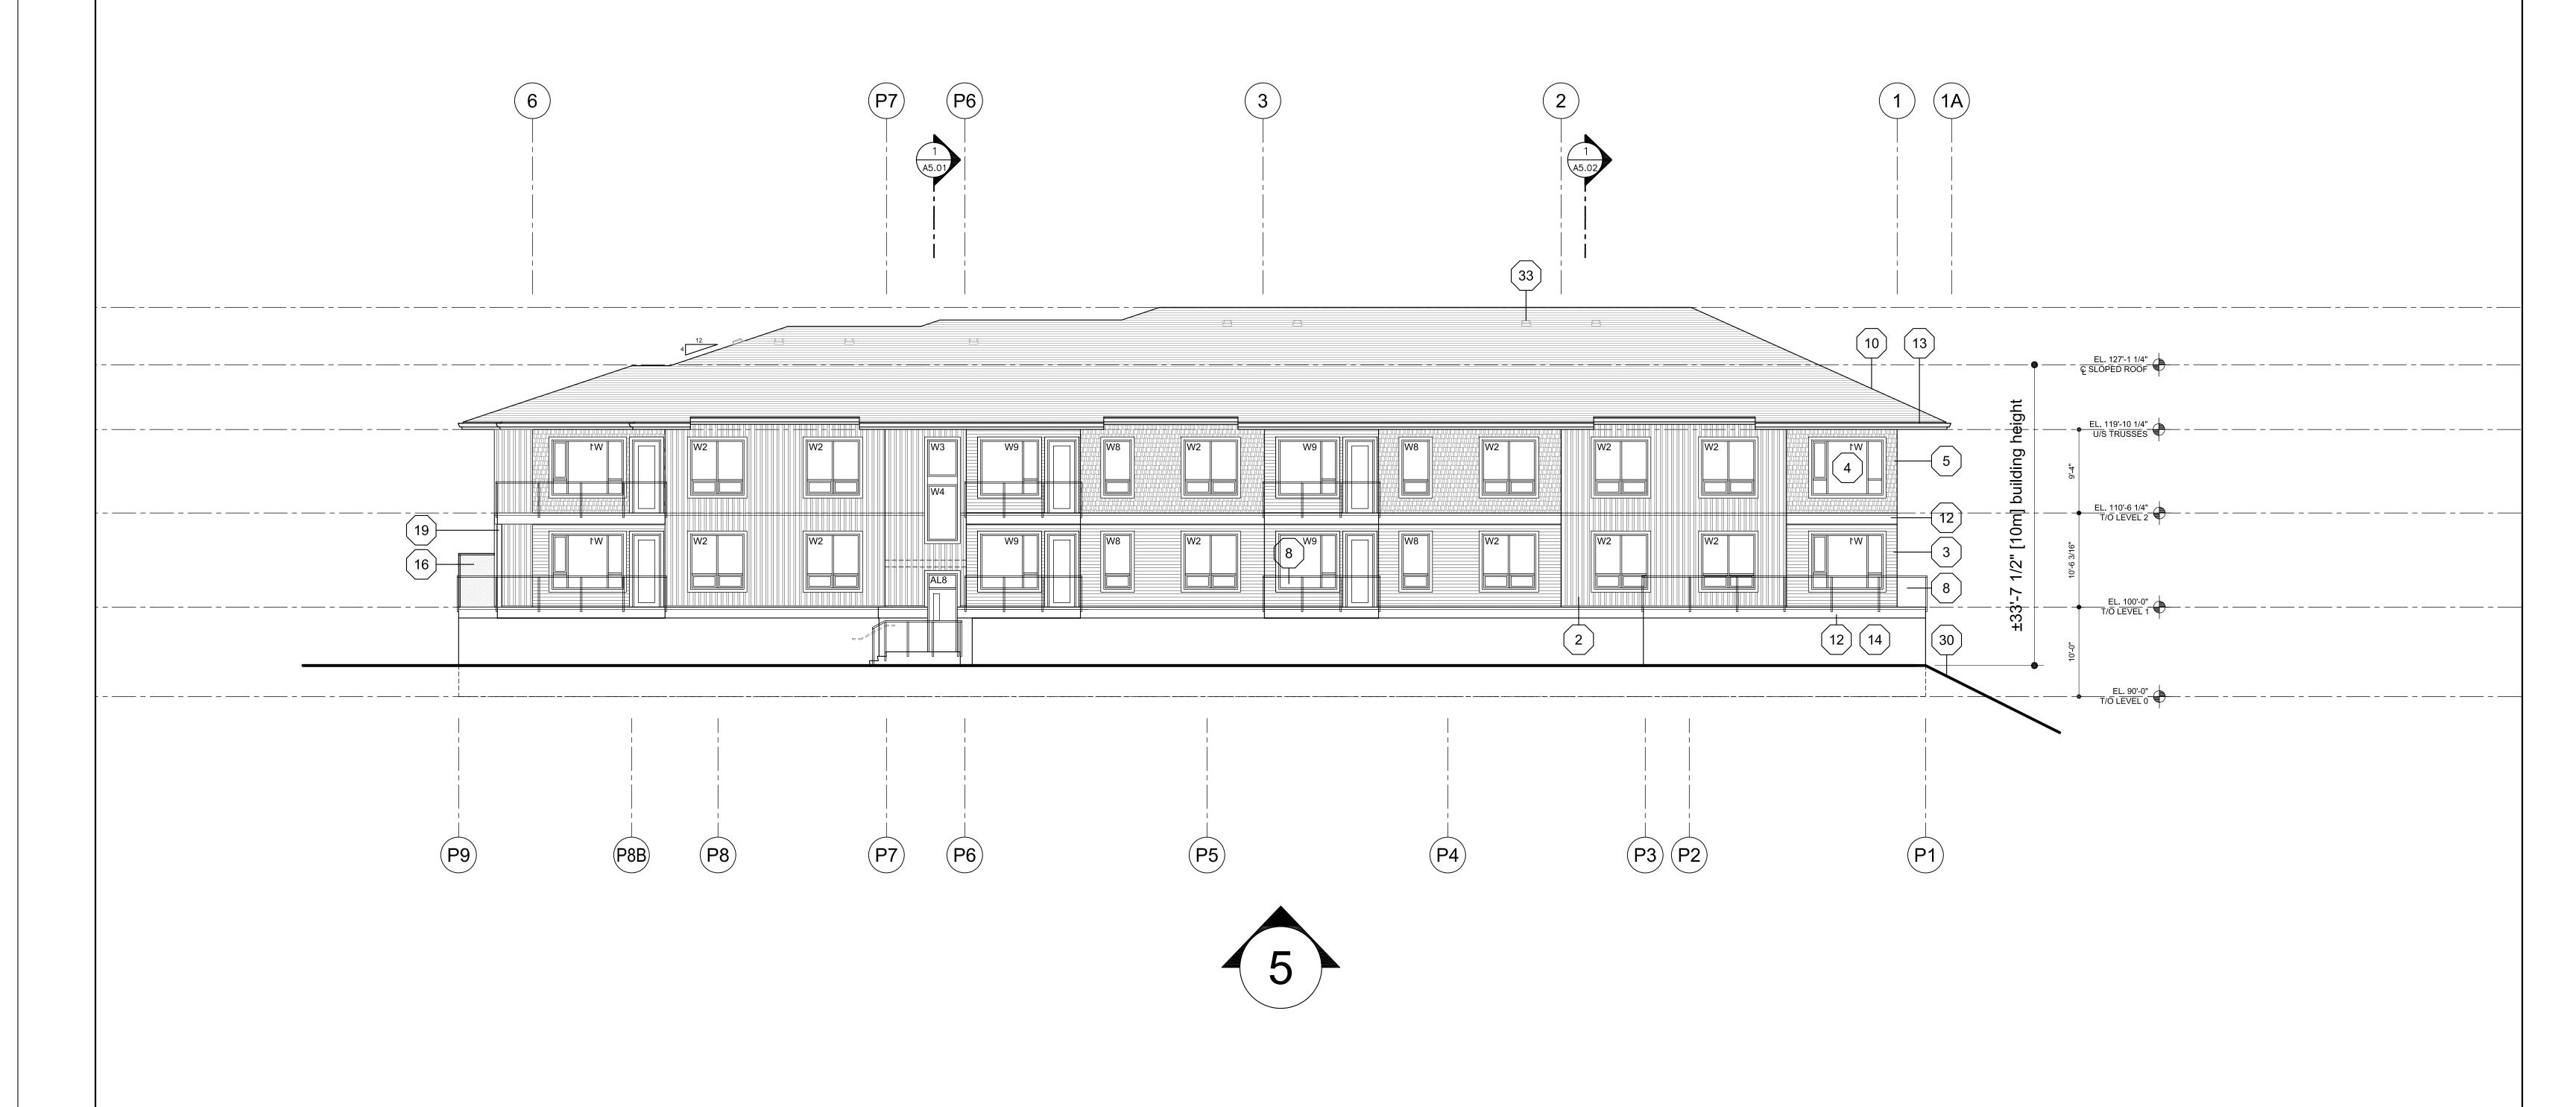
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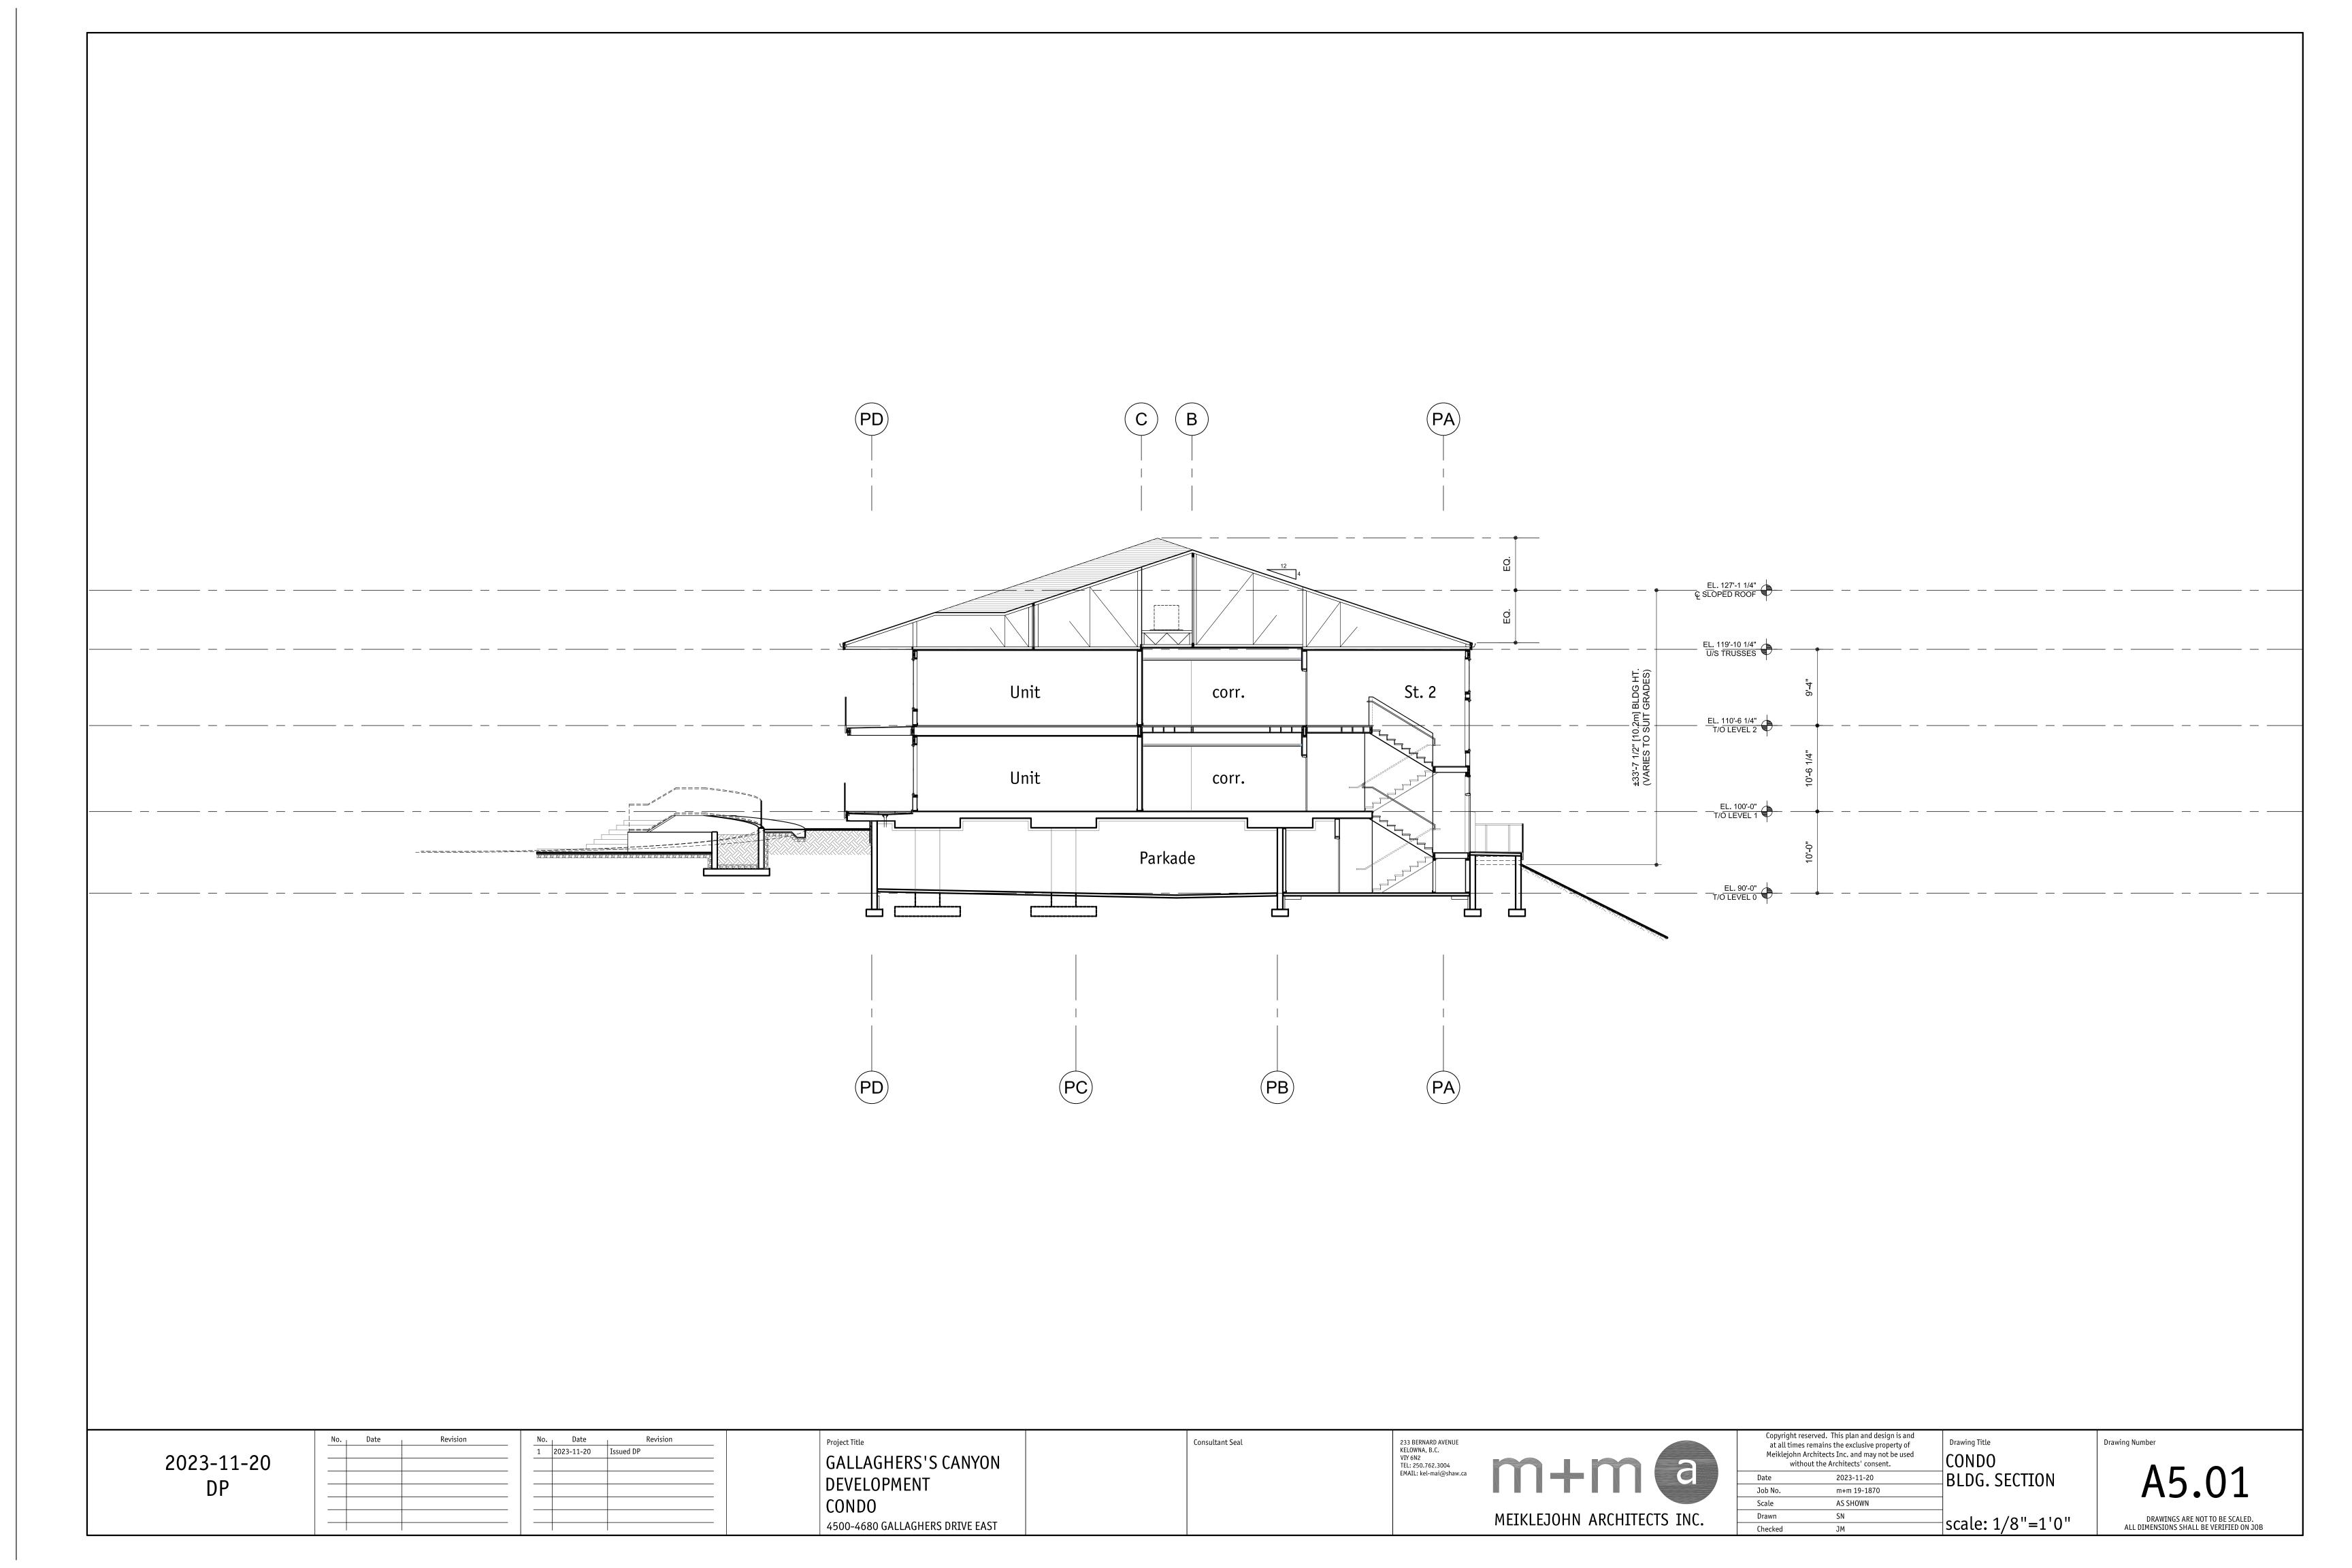
GALLAGHERS'S CANYON
DEVELOPMENT
CONDO
4500-4680 GALLAGHERS DRIVE EAST


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Drawn	SN	$\overline{}$ scale: 1/8"
61 1 1	714	$\neg$ Scale. 1/0

A4.05





REQUIRED FIRE	3.1.3.1.	
MAJOR OCCUPANCIES		
	TOWNHOUSE	
GROUP C TO C	3/4 HR MIN.	3.3.1.1.

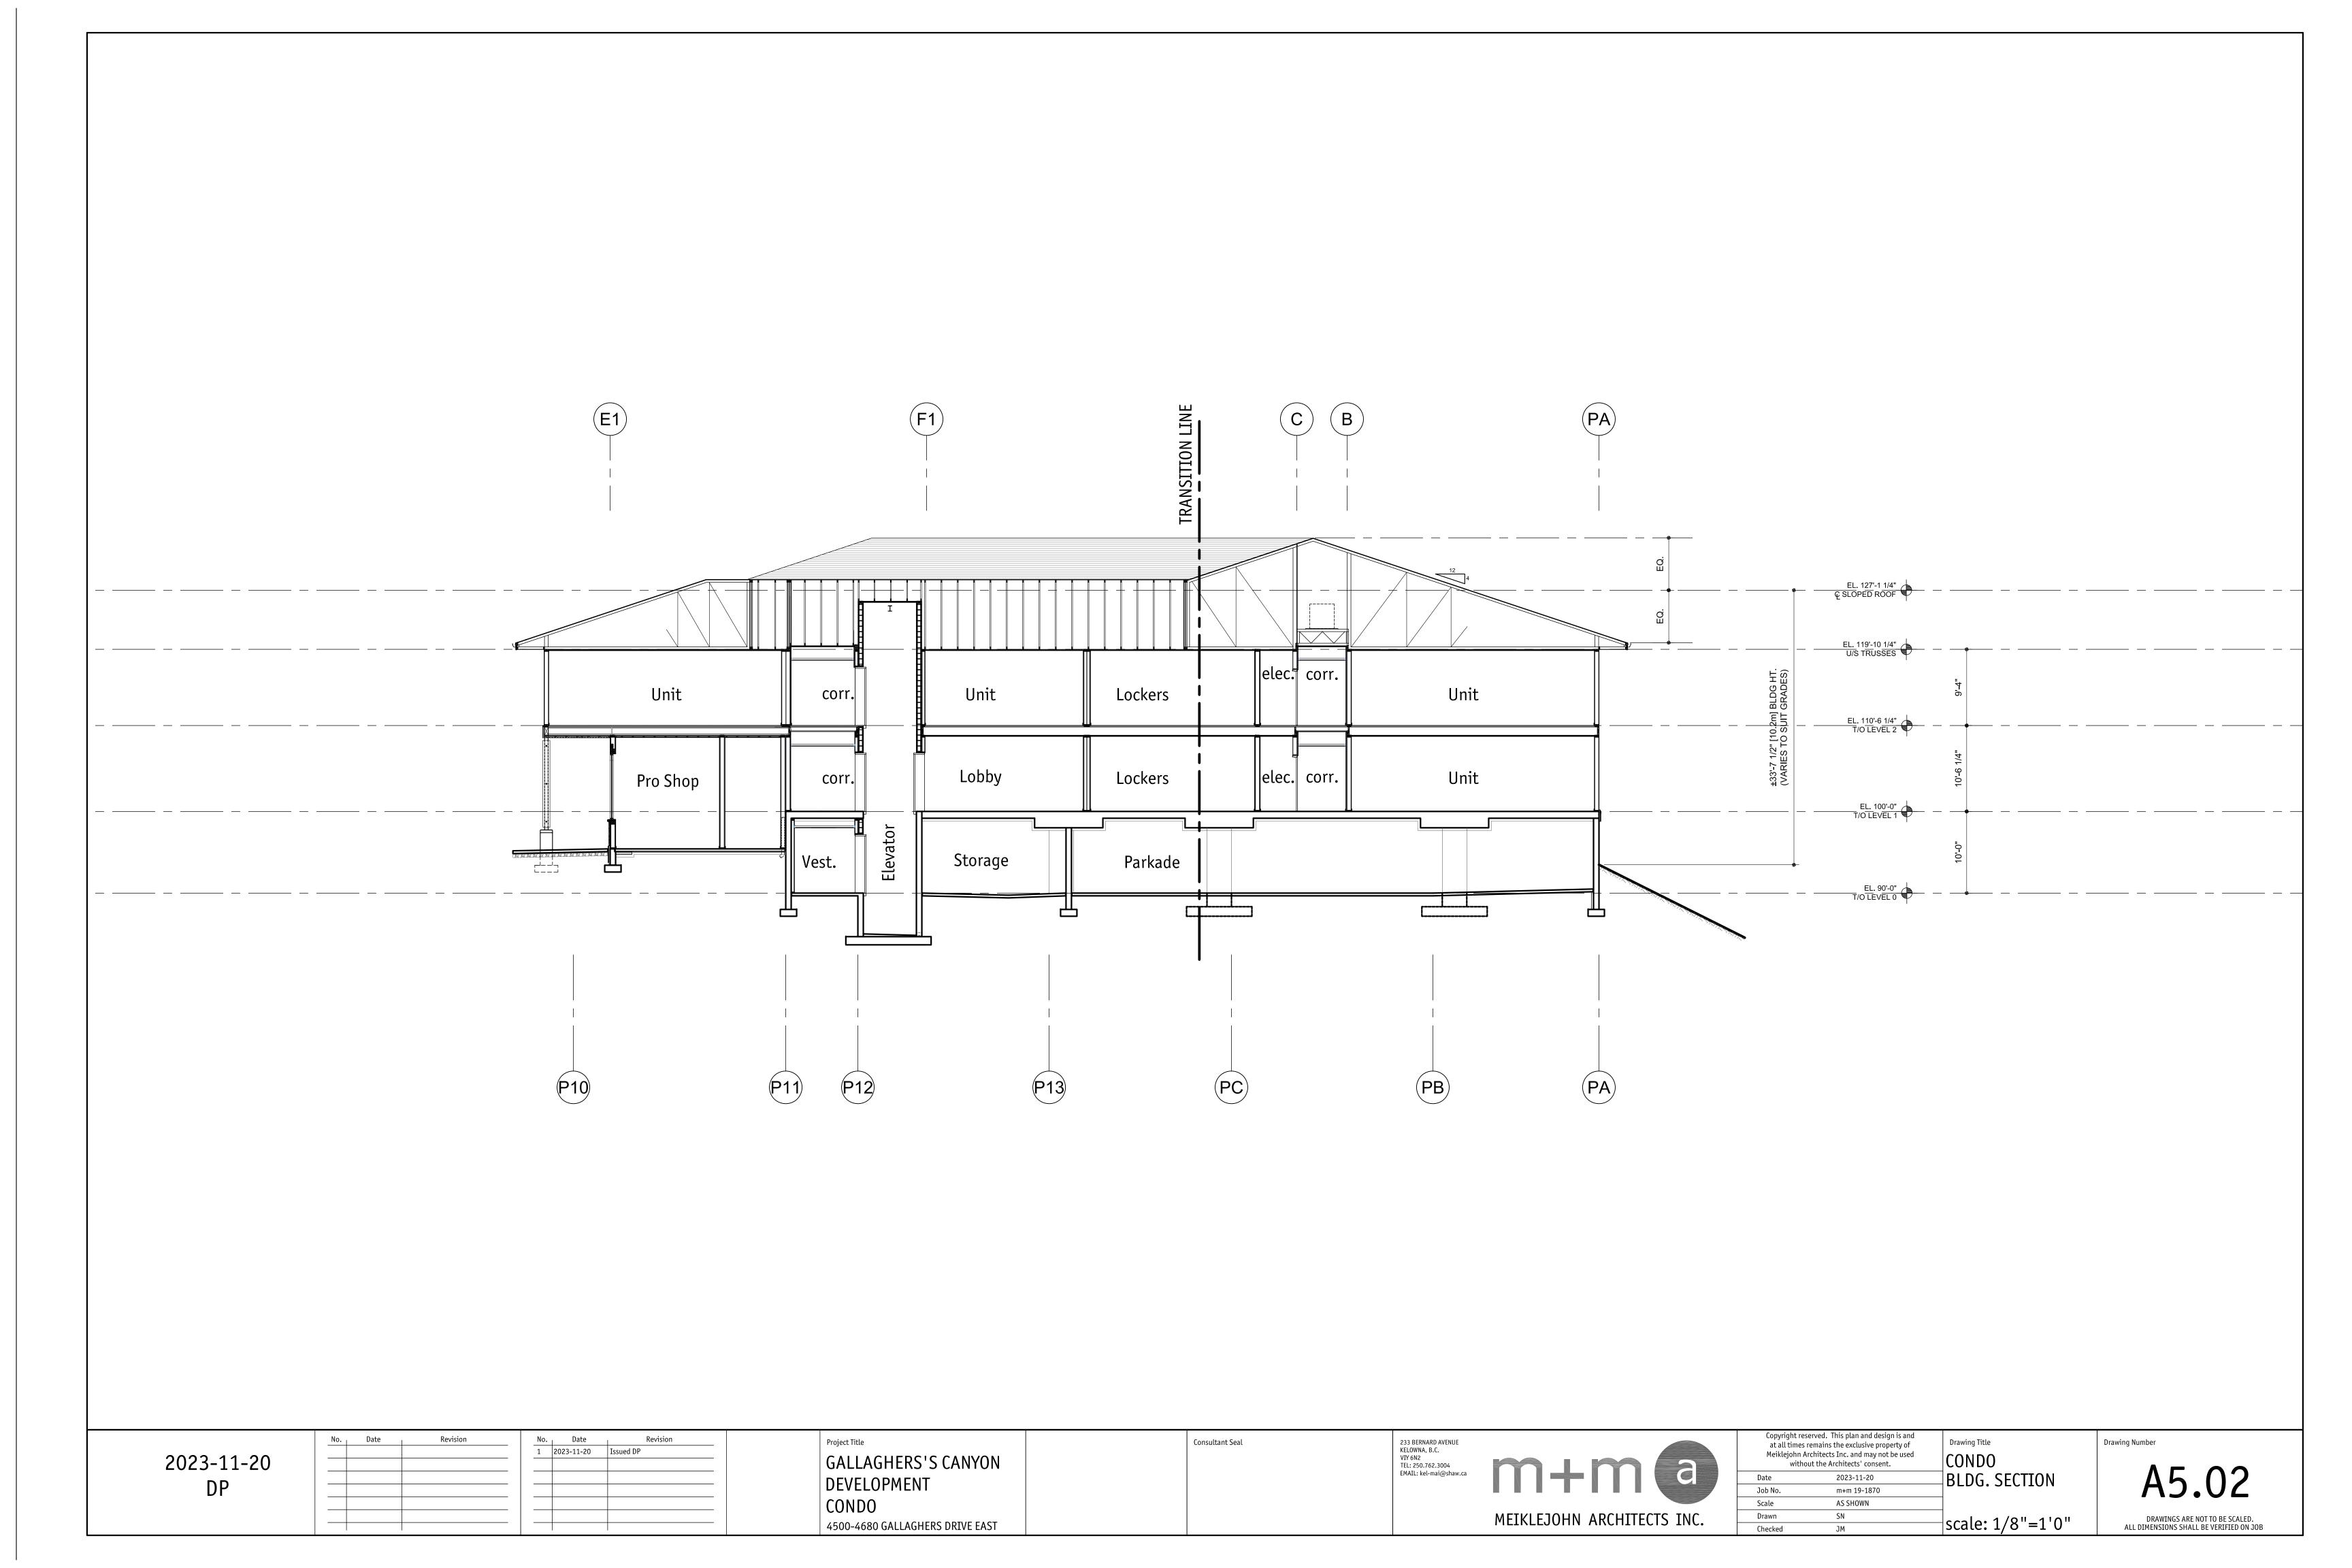BUILDING FIRE SAFETY					
SOFFIT PROTECTION	N/A	3.2.3.16.			
FLAME SPREAD RATINGS	COMPLY WITH	3.1.13.2			
METAL DECK ASSEMBLIES	N/A	3.1.14.2.			
ROOF COVERING CLASSIFICATION	CLASS "A"	3.1.15.2.			
ATTIC FIRESTOPS	YES	3.1.11.			
MAX. ATTIC AREA	300 sm	3.1.11.5.			
MAX. CRAWLSPACE AREA	N/A	3.1.11.6.			
CONCEALED FLOOR AREA	N/A	3.1.11.5.			

### ACCESSIBILITY REQUIREMENTS

NOTE: ACCESSIBILITY NOT REQUIRED FOR TOWNHOUSES

WASHROOM FIXTURES REQUIREMENTS				
MIN. 1 REQ'D,/ DWELLING UNIT	3.7.2.2.(11)			

CONDO SPATIAL SEPARATION 3			2.3.1.D
	REAR YARDS	SIDE YARDS	SOUTH / FRONT YARD
WALL AREA	±57sm	±57sm	window openings & walls
OPENING AREA	±18.6 sm	±18.6 sm	construction un-restricted. limiting distance exceeds
% PROVIDED	±32.5%	±32.5%	7.0m (residential)
LIMITING DISTANCE	5.0 m	5.0 m	or building faces a street in accordance with
% PERMITTED	±39%	±39%	3.2.3.10.(2)
CONSTRUCTION TYPE	COMBUST./NON-COMBUST.	COMBUST./NON-COMBUST.	
CLADDING MATERIAL	NON-COMBUSTIBLE	NON-COMBUSTIBLE	
REQUIRED RATINGS	45 MINUTES	45 MINUTES	

BUILDING CODE REVIEW BCBC 2018						
OCCUPANCY	GROUP C		GROUP C			
	TOWNHOUSES - BUILDINGS 1, 2 & 3		TOWNHOUSES - BUILDINGS 4,5 &			
ARTICLE	3.2.2.53		PART 9			
NO. OF STOREYS	2 STOREY		2 STOREY			
NO. OF STREETS FACING	1	1				
BUILDING AREAS:	PROPOSED	CODE MAX.	PROPOSED	CODE MAX.		
	622.5 sm	900 sm	451sm MAX.	600sm		
CONSTRUCTION TYPE	COMBUST./NON-C	COMBUST.	COMBUST./NON-COMBUST.			
SPRINKLERED	NOT REQUIRED		NOT REQUIRED			
ASSEMBLY RATINGS:						
FLOOR	3/4 HR		3/4 HR			
WALLS / BEARING STRUCTURE	3/4 HR	3/4 HR				
ROOFS	NO RATING REQUIRED		NO RATING REQ	UIRED		

FIRE PROTECTION:	3.2.5.	PART 9
	TOWNHOUSE - BLDG. 1, 2 & 3	TOWNHOUSE - BLDG. 4, 5 & 6
LOCATION OF HYDRANT :	90m MAX TO ENTRY 3.2.5.5.	90m MAX TO ENTRY
STANDPIPE/HOSE	NA	NA
SPRINKLERED	NA	NA
FIRE ALARM SYSTEM	NA	NA
EXIT LIGHTS	NA	NA
EMERGENCY LIGHTING	NA	NA

OCCUPA	NT LOAD	TABLE 3.1.17.1.(1b)					
TOWNHOUSES							
BUILDING 1	2 PERSONS / SLEEPING RMS x 12 RMS	24 PERSONS					
BUILDING 2	2 PERSONS / SLEEPING RMS x 12 RMS	24 PERSONS					
BUILDING 3	2 PERSONS / SLEEPING RMS x 12 RMS	24 PERSONS					
BUILDING 4	2 PERSONS / SLEEPING RMS x 9 RMS	18 PERSONS					
BUILDING 5	2 PERSONS / SLEEPING RMS x 9 RMS	18 PERSONS					
BUILDING 6	2 PERSONS / SLEEPING RMS x 9 RMS	18 PERSONS					

EXIT FACILITIES						
TOWNHOUSES		3.1 to 3.6				
	min. 800mm door width as per 3.4.3.2.(A)					
PROVIDED	DOOR					
TOWNHOUSE UNITS	min. 1 door @ 800mm (each unit)					
EXIT THROUGH LOBBY	N/A					
PANIC HARDWARE REQ'D	N/A	3.4.6.16.(2)				
EXIT EXPOSURE	ОК	3.2.3.13.				
MAX. TRAVEL DISTANCE	30m	3.4.2.5.(1)				
EXIT RATINGS REQUIRED:						
STAIR SHAFTS	N/A	3.4.4.1.				
CORRIDORS	N/A	3.3.2.6.(4)				

TOWNHOUSE	S SITE CO	OVERAGE	& IMPERN	//EABLE S	SURFACES
	building footprint area (sf)	building footprint area (sm)	paved driveway area (sf)	paved driveway area (sm)	
			15,121		driveway
BUILDING 1	6,700	622.5	220		driveway
			200		driveway
			207		driveway
			320		driveway
BUILDING 2	6,700	622.5	360		driveway
			423		driveway
			380		driveway
			313		driveway
BUILDING 3	6,700	622.5	313		driveway
			160		driveway
			280		driveway
			512		driveway
BUILDING 4	5,024	466.7	358		driveway
			203		driveway
			227		driveway
BUILDING 5	5,024	466.7	401		driveway
			213		driveway
			302		driveway
BUILDING 6	5,024	466.7	210		driveway
			223		driveway
			235		driveway
			812		visitor stalls
TOTAL	35,172	3,268	21,993	2,043	
Max site coverage of all buildings (55%)	23.9%		,	, , ,	1
Max site coverage of all buildings, structures and impermeable surfaces (80%)			38.9%		

TOWNHO	JSES GFA				
BUILDING 1		±sf	±sm		
	L0 - include garage	6,700	622		
	L1	4,220	392		
	Subtotal			10,920	1,050
BUILDING 2				10,920	1,050
BUILDING 3				10,920	1,050
BUILDING 4	L1	5,024	467		
	L2	2,871	267		
	Subtotal			7,895	733
BUILDING 5				7,895	733
BUILDING 6				7,895	733
			Total	56,445	5,244

Page 144 4.0 sm per unit of amenity space, ac and not located wi	cessible to a	ıll resid	dents			
	sm					
bachelor	7.5				sm	total sm
1 bed	15.0	Tota	al Townhouses units	21 - 3b	25	525
1 bed or more	25.0					
				R	equired amenity	525
			Requir	ed common ameni	ty = 4.0 sm x 21	84.0
PRIVATE AMENIT	Y SPACE					
BUILDING 1						
101	L1		290	26.9		
	L2		484	45.0		
102	L1		290	26.9		
	L2		484	45.0		
103	L1		290	26.9		
	L2		484	45.0		
104	L1		290	26.9		
	L2		484	45.0		
					3,096	288
BUILDING 2					3,096	288
BUILDING 3					3,096	288
BUILDING 4						
101	L0		484			
	L1		290			
102	L0		484			
	L1		290			
103	L0		484			
	L1		290			
					2,322	216
BUILDING 5					2,322	216
BUILDING 6					2,322	216
			Total Provided		16,254	1,510

STALL SIZE		WIE	OTH	LENG	TH	HEIG	HT		
REGULAR SIZE	STALL	8'-3"	2.5m	19'-8"	6.0	m 6'-7"	2.0m	-	
SMALL SIZE STALL (50% max)		7'-6"	2.3m	15'-9"	4.8	m 6'-7"	2.0m		
ACCESSIBLE S	ΓALL	12'-10"	3.9m	19'-8"	6.0	m 6'-7"	2.3m	1	
VAN ACCESSIB	LE STALL	15'-9"	4.8m	19'-8"	6.0	m 7'-7"	2.3m		
REGULAR PARA	ALLEL STALL	8'-7"	2.6m	23'-0"	7.0	m 7'-7"	2.3m		
SMALL PARALL	EL STALL	8'-3"	2.5m	21'-4"	6.5	m 6'-7"	2.0m		
DRIVE AISLES (		21'-4"	6.5m	_	_	6'-7"	2.0m		
LOADING AREA		28 sm	3,0 m v	l width	4.0	m overhea		-	
23, D.110 / 11 C.A	•		RED PA		1				
B 11	0			unit#		# bed	#	stall	
Parking (	&	BUILDI	NG 1	101		3b	2	2.0	
Loading	area			102		3b	1	2.0	
(pg 90)						3b	2	2.0	
(ha an)				104		3b	2	2.0	
	no of stall								8.0
bachelor	1.0	BUILDI	NG 2						8.0
1b	1.25	BUILDI	NG 3						8.0
2b	1.5								
3b or more	2.0	BUILDI	NG 4	101		3b		2.0	
				102		3b		2.0	
visitor per unit	0.14			103		3b		2.0	
									6.0
		BUILDI	NG 5						6.0
		BUILDI	NG 6						6.0
						Required	Resid.		42.0
						Total Towr	house un	its = 21	
						Required		21	2.94
					$\dashv$	Required			44.9
						Provided <sup>-</sup>			47.0
CRU Loadii	ng area (Tab	le 8.4)	) - N.A	<del>ــــــ</del>					
	<u> </u>	1	,900 sm						
		1 (size:							

	building footprint area (sf)	building footprint area (sm)	paved driveway area (sf)	paved driveway area (sm)	
			15,121		driveway
BUILDING 1	6,700	622.5	220		driveway
			200		driveway
			207		driveway
			320		driveway
BUILDING 2	6,700	622.5	360		driveway
	·		423		driveway
			380		driveway
			313		driveway
BUILDING 3	6,700	622.5	313		driveway
	,		160		driveway
			280		driveway
			512		driveway
BUILDING 4	5,024	466.7	358		driveway
	-,		203		driveway
			227		driveway
BUILDING 5	5,024	466.7	401		driveway
			213		driveway
			302		driveway
BUILDING 6	5,024	466.7	210		driveway
			223		driveway
			235		driveway
			812		visitor stalls
TOTAL	35,172	3,268	21,993	2,043	
Max site coverage of all buildings (55%)	23.9%				
Max site coverage of all buildings, structures and impermeable surfaces (80%)			38.9%		

TOWNHOUSES - BUILDINGS 4, 5 & 6				
Not exceeding 600sm building area Part 9 (1.3.3.3.)				
Required Max. Building Area 600 sm 6,458				
Proposed Building 4 Footprint Area include projection of building above (Building 5 & 6 similiar)	466.7 sm	5,024 sf		

ADDRESS		4500 - 4680 GALLAG	4500 - 4680 GALLAGHERS DRIVE EAST					
LEGAL DESCRIPTION		PART OF LOT A & AN UNDIVIDED 1/24th SHARE IN LOT G PLAN KAP53116 SECTIONS 1 & 12 TOWNSHIP 26 ODYD PLAN KAP66064						
DEVELOPMENT PE	RMIT AREA	YES						
EXISTING ZONING		P3 - PARKS & OPEN	SPACE					
PROPOSED ZONIN	G	MF2 - TOWNHOUSE	HOUSING					
EXISTING LEGAL U	SE	SINGLE FAMILY RES						
GRADES		EXISTING AVERAGE	- SLOPE					
MF2 - TOW	'NHOUSE H	OUSING						
CRITERIA		REQUIRED		PROVIDED				
MININUM LOT WIDT	ГН	20.0m		±80.0m				
MININUM LOT DEP		30.0m		±120.0m				
MININUM LOT AREA	A	900sm		±146,888sf				
NANVINALINAL OT A DE	- A	NI A		±13,646sm				
MAXIMUM LOT ARE	EA .	N.A.	42.0	N.A.				
Table 8.3		TOWNHOUSES	42.0 2.94	47 				
off-street pa	arking	VIOLICIA	2.34	-				
		TOTAL	44.9					
Coverage		max site coverage of all buildings = 55%	l I	23.9%				
		buildings, structures	and impermeable surfaces					
Max. densit	У	max base FAR = 1.0	max base FAR = 1.0					
Max. base height		11.0m & 3 storeys	11.0m & 3 storeys					
with walkout basements	front bldg elev	10.0m & 3 storeys						
	rear bldg elev	12.6m & 3 storeys		-				
Min front ya flanking sid setback south (GALLAGHE	e yard	3.0m		3.0m min.				
Min building from front y flanking sid	ard and e yard	N.A.		N.A.				
Min side ya	rd setback	3.0m		3.0m min.				
WEST (GOLF COUF	RSE)							
Min side ya	rd setback	3.0m		3.0m min.				
EAST (GALLAGHER								
Min rear yard setback		4.5m		4.5m min.				
		private accept 505	em.	private amonite: 4.5				
Min commo private ame		private amenity = 525s (include 84sm commo		private amenity = 1,5 common amenity = 37 total = 1,88				
				1				

BUILDING 1			±sf	±sm		
	101	T1	2,227	207		
	102	T1	2,227	207		
	103	T1	2,227	207		
	104	T1	2,227	207		
	Subtotal				8,908	828
BUILDING 2					8,908	828
BUILDING 3					8,908	828
BUILDING 4						
	101	T2	2,127	198		
	102	T2	2,127	198		
	103	T2	2,127	198		
	Subtotal				6,381	593
BUILDING 5					6,381	593
BUILDING 6					6,381	593
				Total	45,867	4,261

N.A.

MF2

N.A.

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No. Date Revision

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GALLAGHERS'S CANYON
DEVELOPMENT
TOWNHOUSES
4500-4680 GALLAGHERS DRIVE EAST



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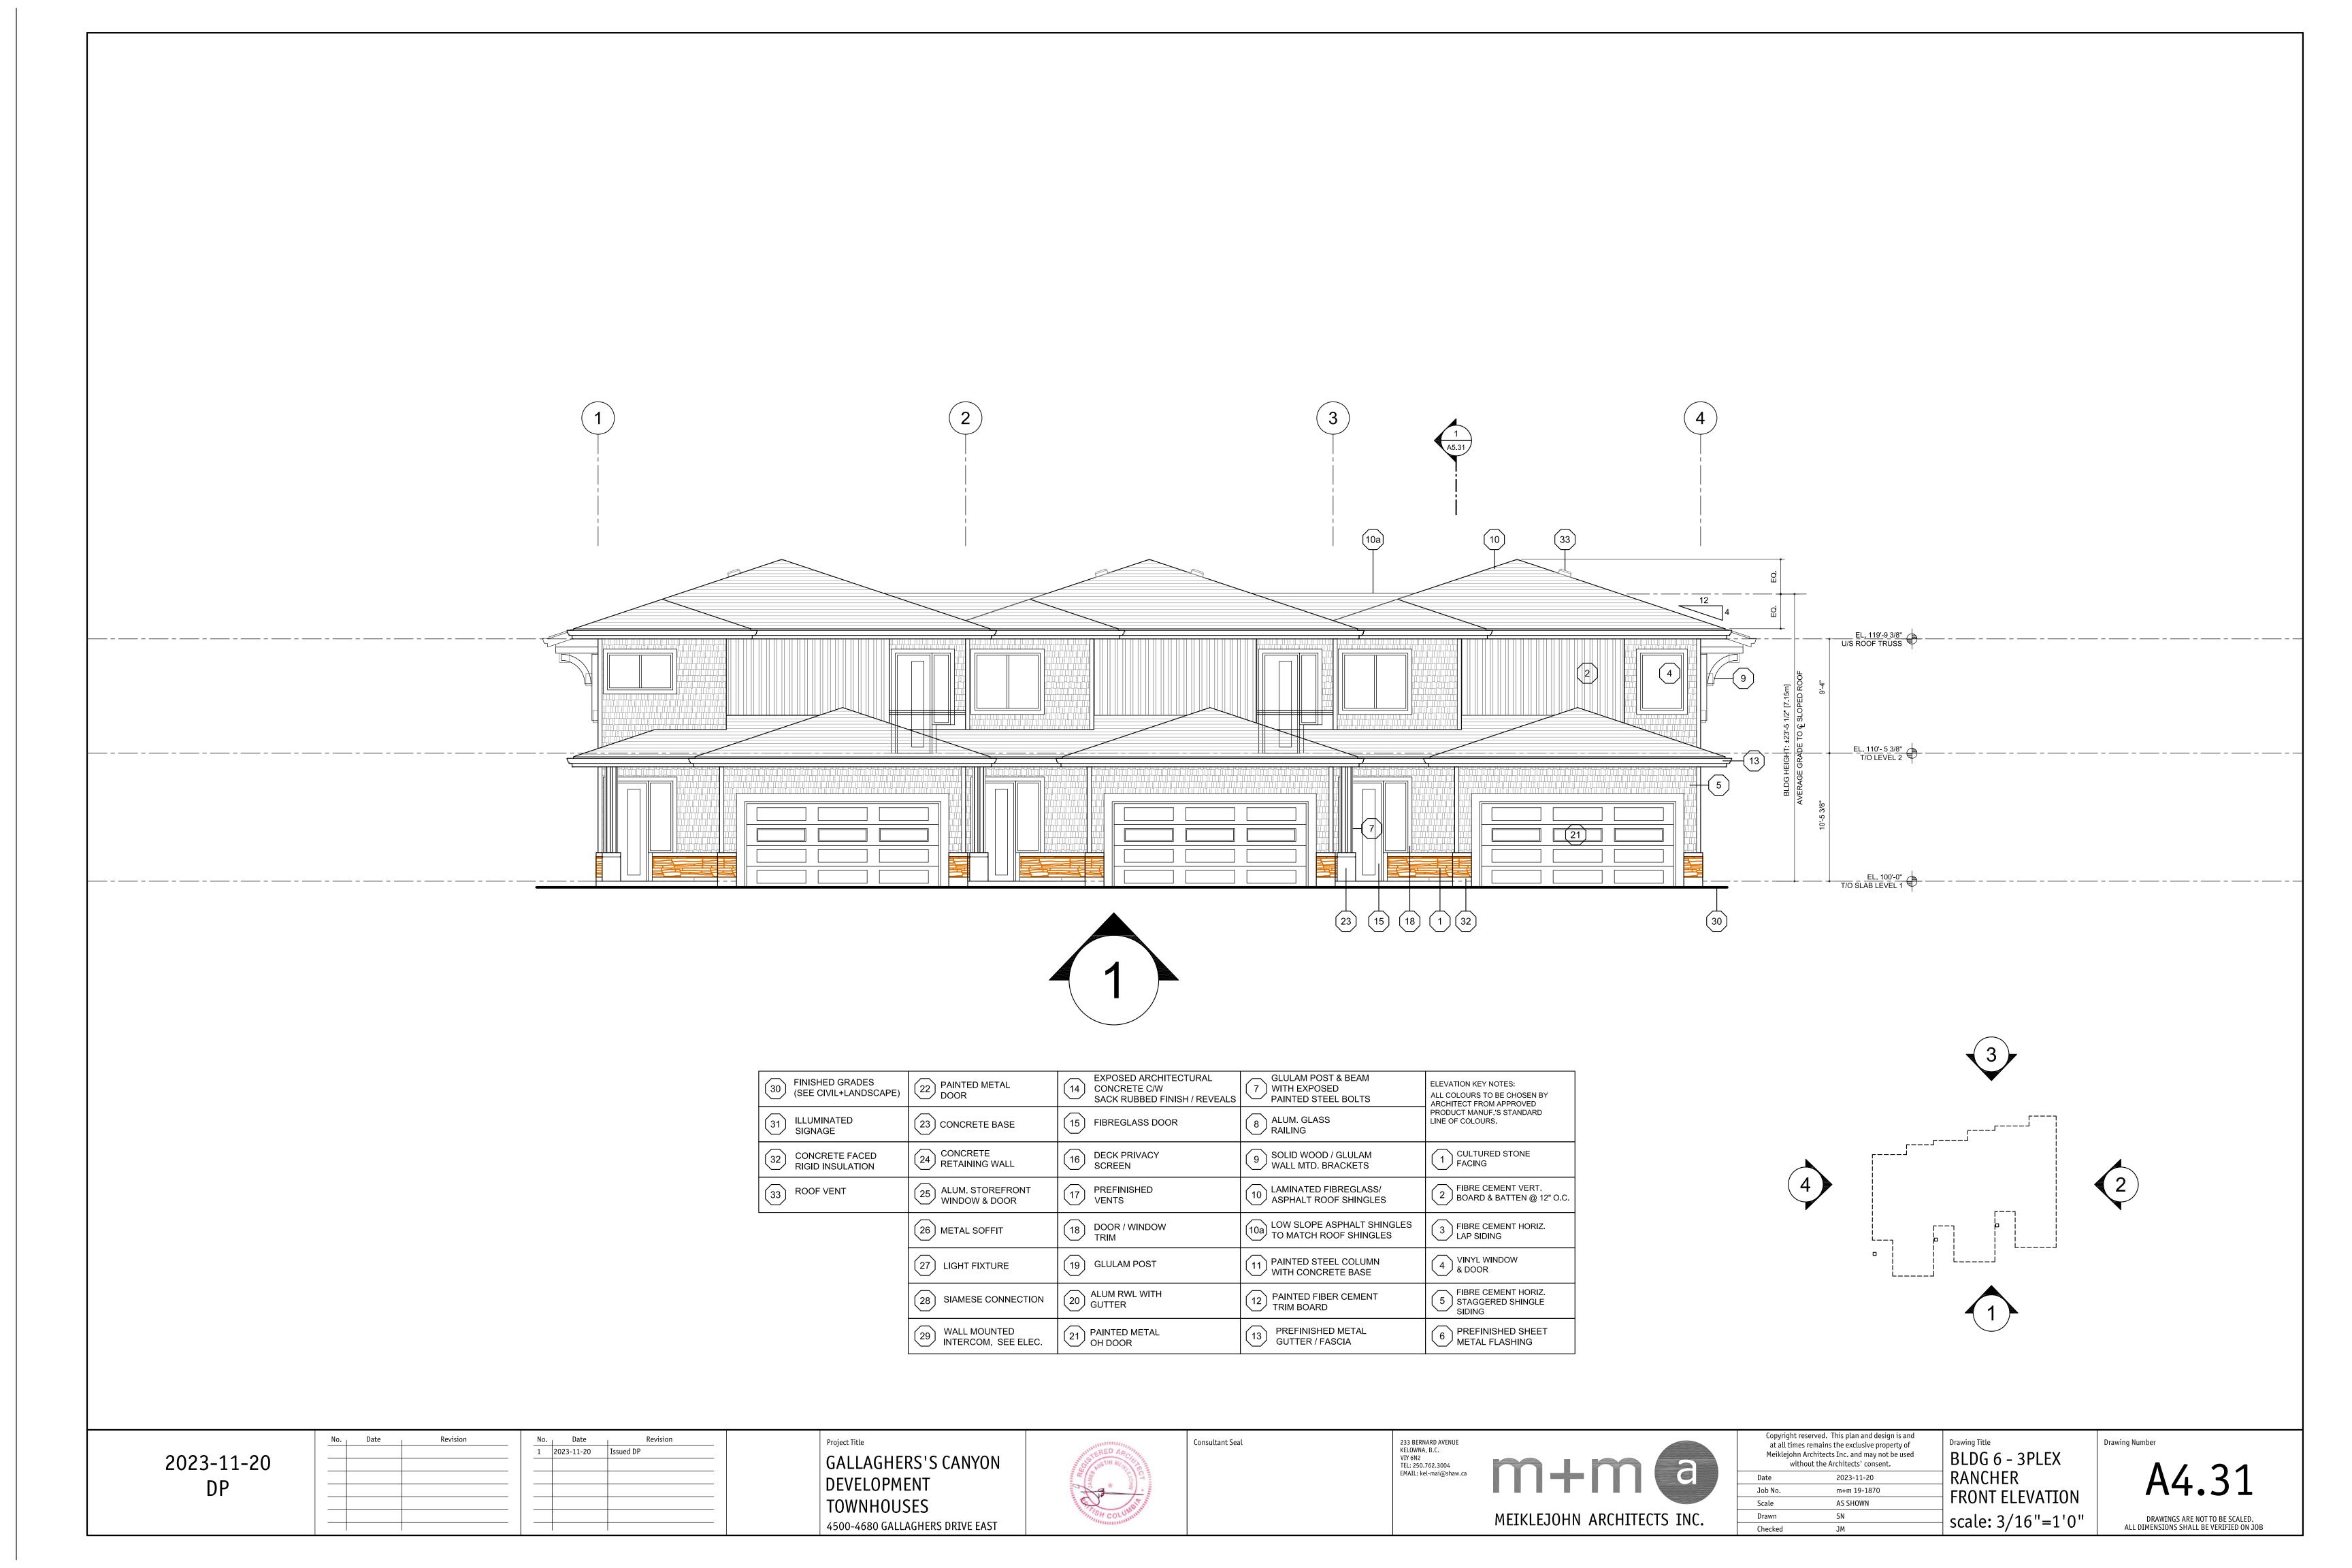
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Scale	AS SHOWN

TOWNHOUSES
ZONING & CODE
SUMMARY


NUMBER OF LOADING SPACES

Drawing Number

A1.2





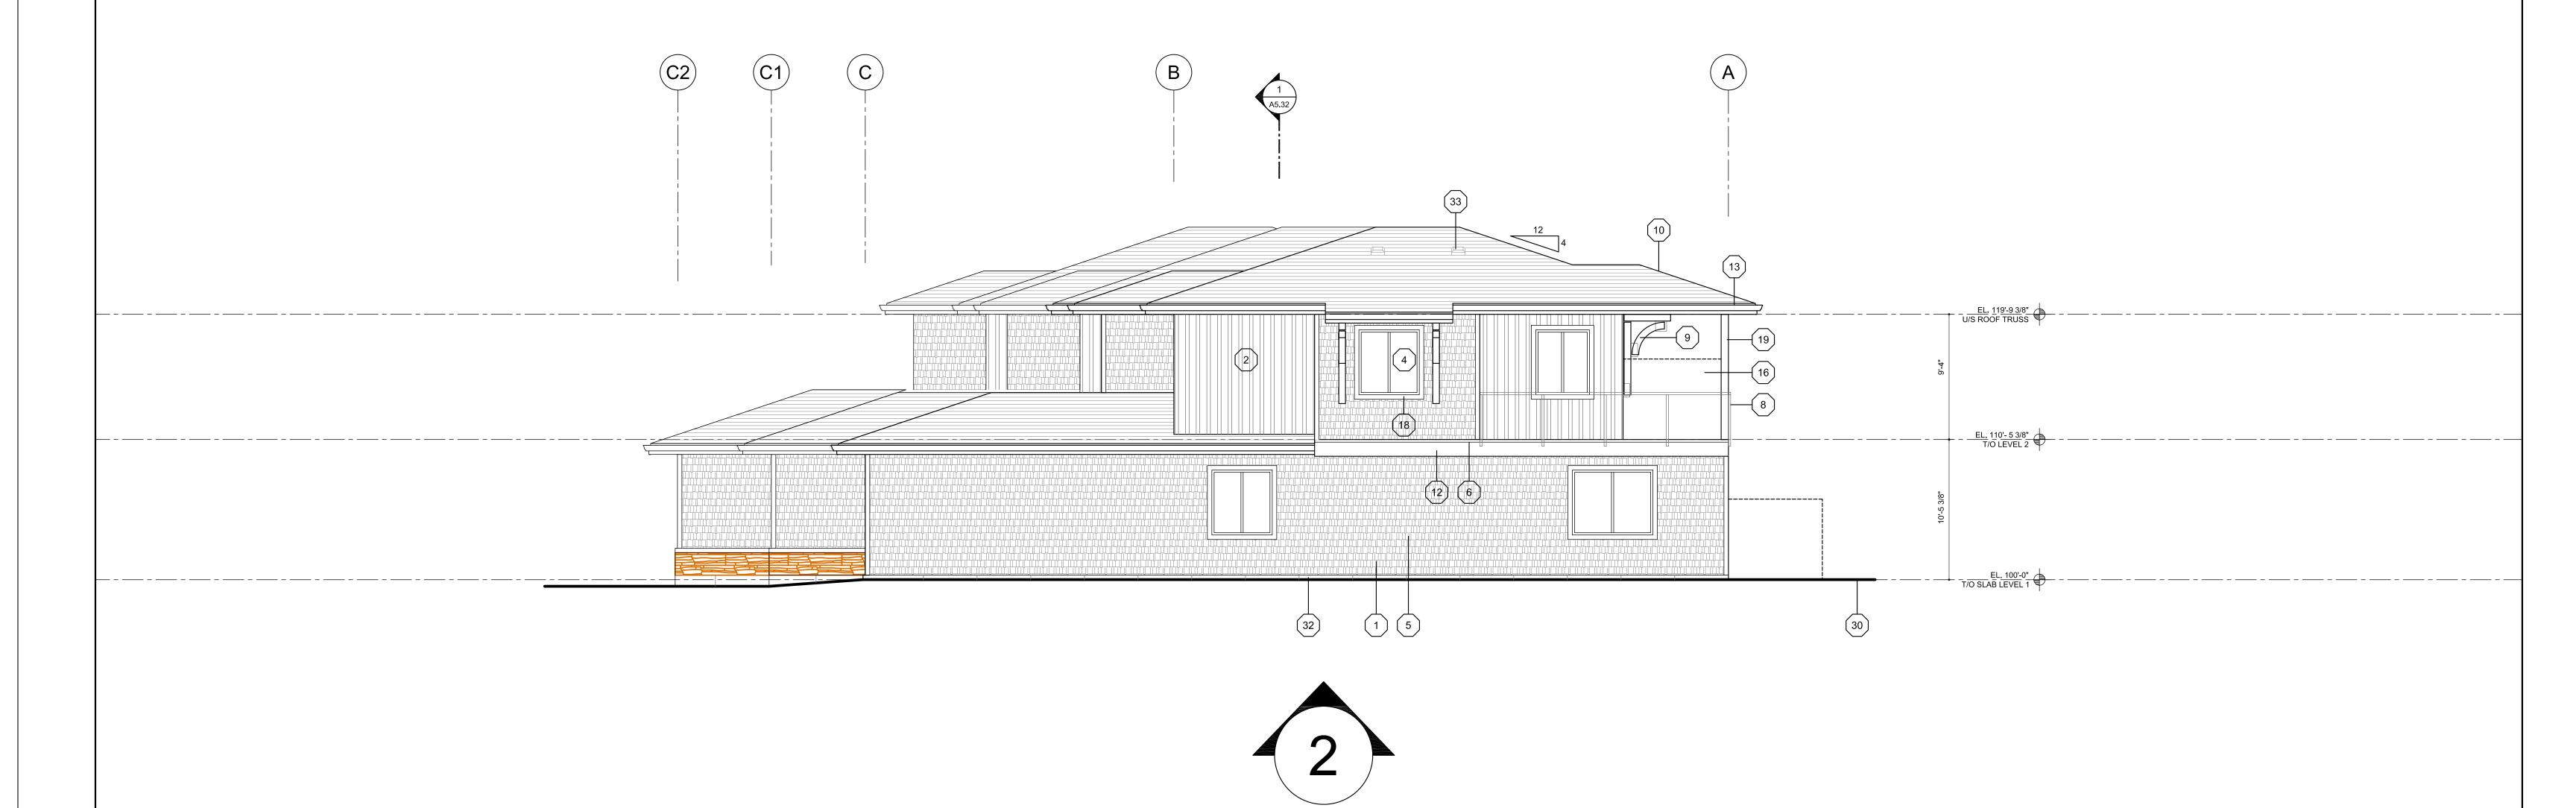

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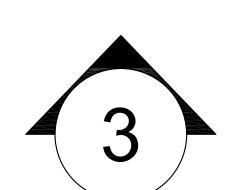


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Date	2023-11-20	RANCHER
Job No.	m+m 19-1870	RIGHT ELEVATION
Scale	AS SHOWN	KIGIII LLLVAIION
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- 3PLEX ELEVATION








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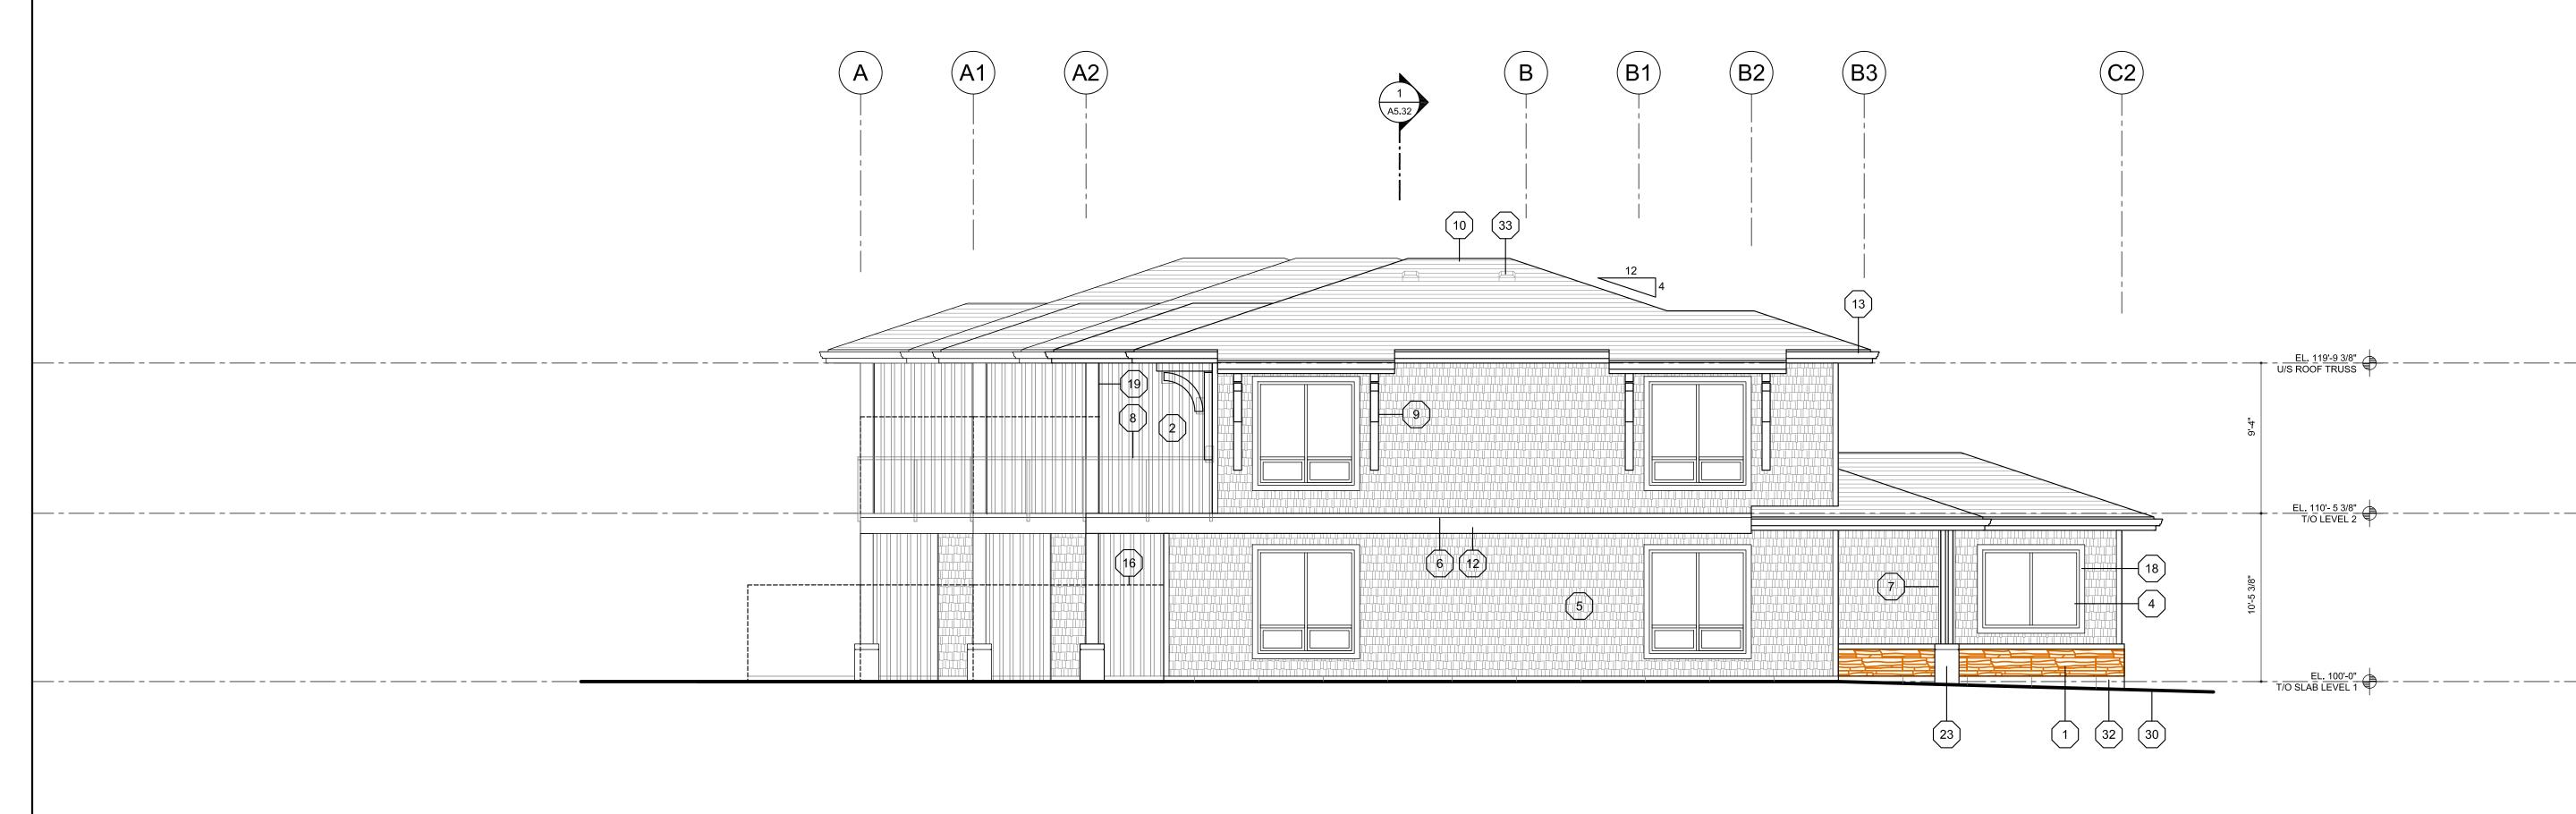
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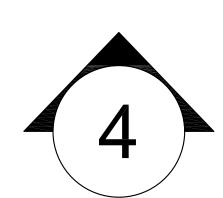
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Date 2023-11-20 RANCHER	
Job No. m+m 19-1870  Scale AS SHOWN  REAR ELEVATION	
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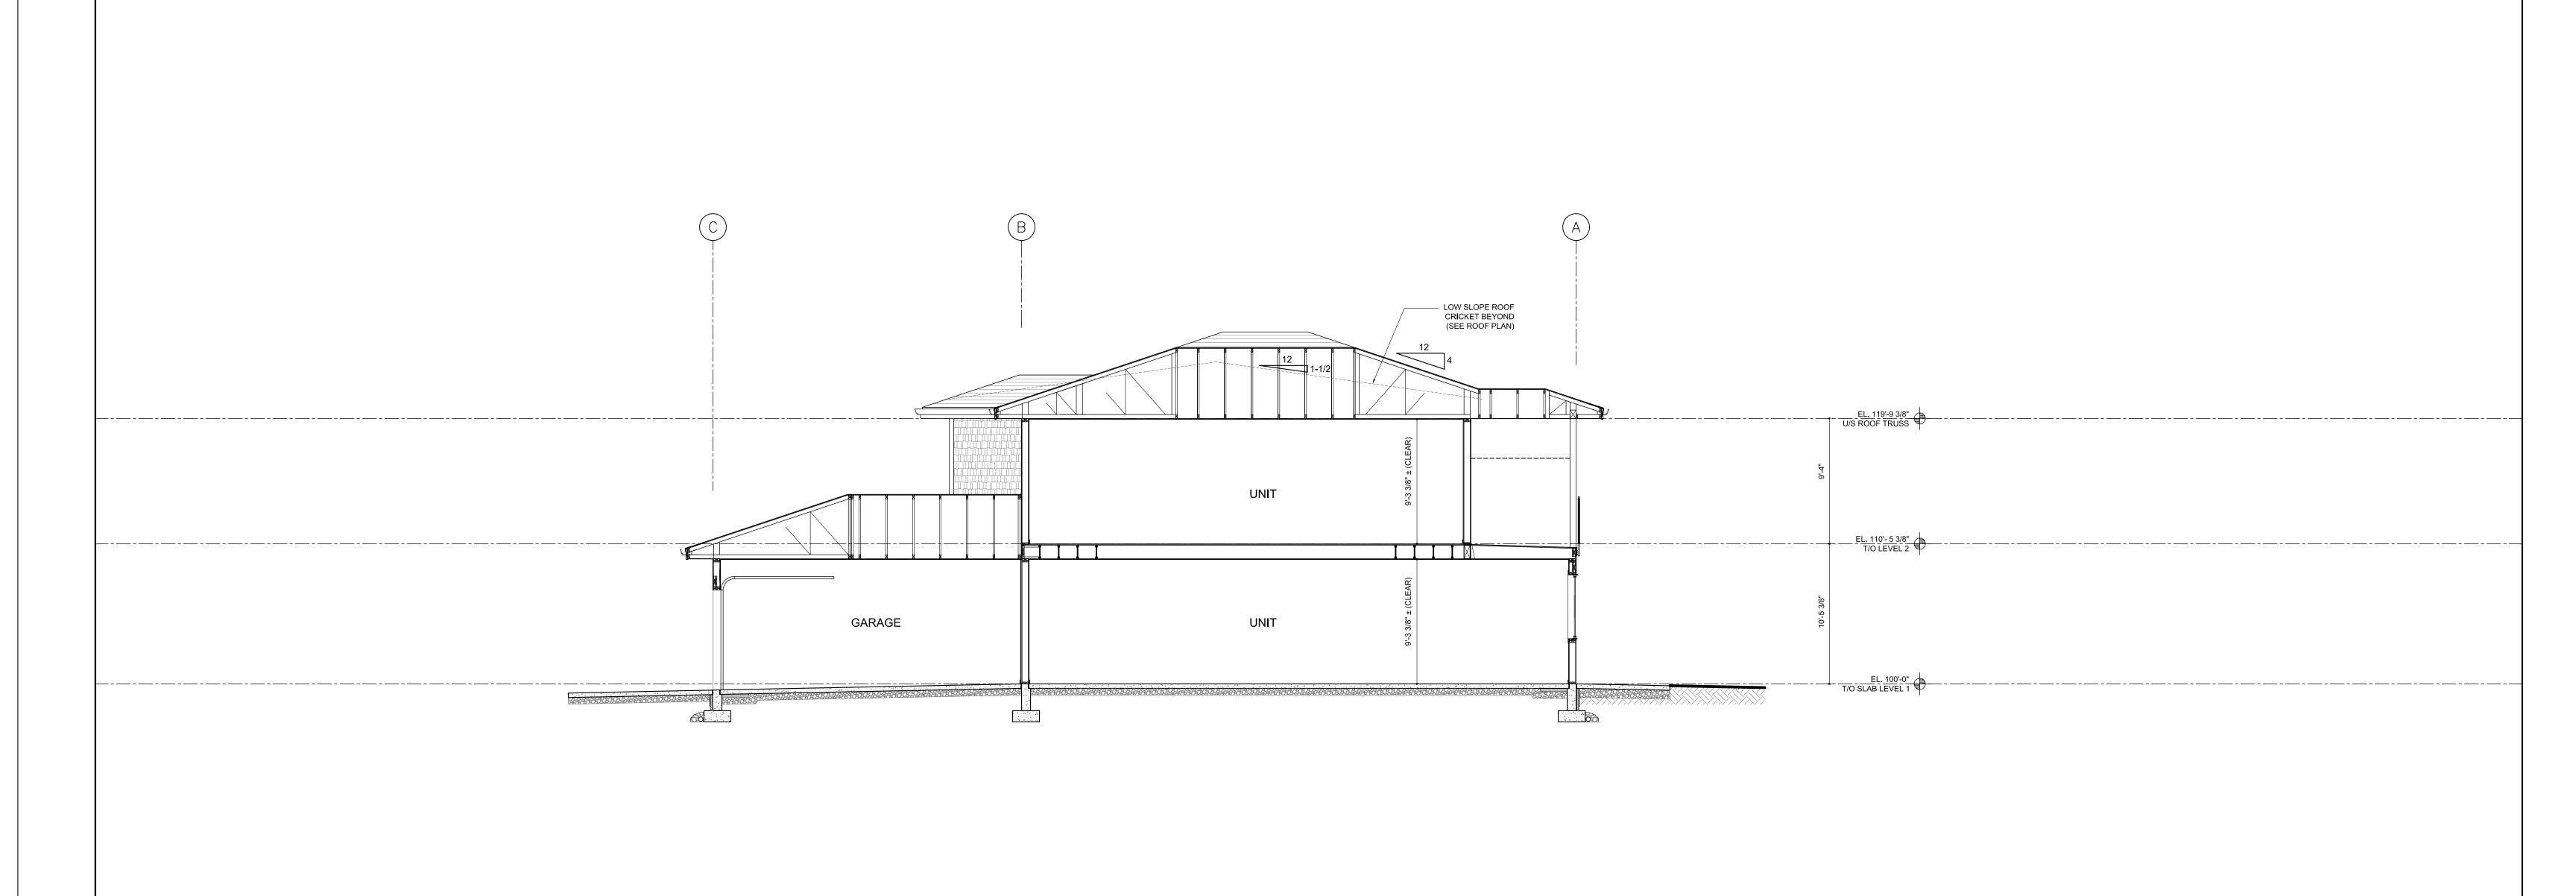
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	MEIKLEJOHN ARCHITECTS INC.

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Date	2023-11-20	□ RAN
Job No.	m+m 19-1870	
Scale	AS SHOWN	
Drawn	SN	

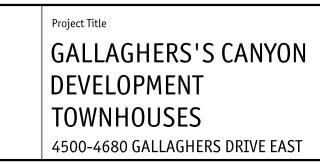Checked

Drawing Title
BLDG 6 - 3PLEX
RANCHER
LEFT ELEVATION
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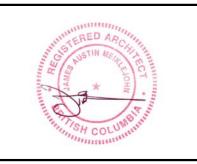
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GALLAGHERS'S CANYON

DEVELOPMENT

TOWNHOUSES

4500-4680 GALLAGHERS DRIVE EAST



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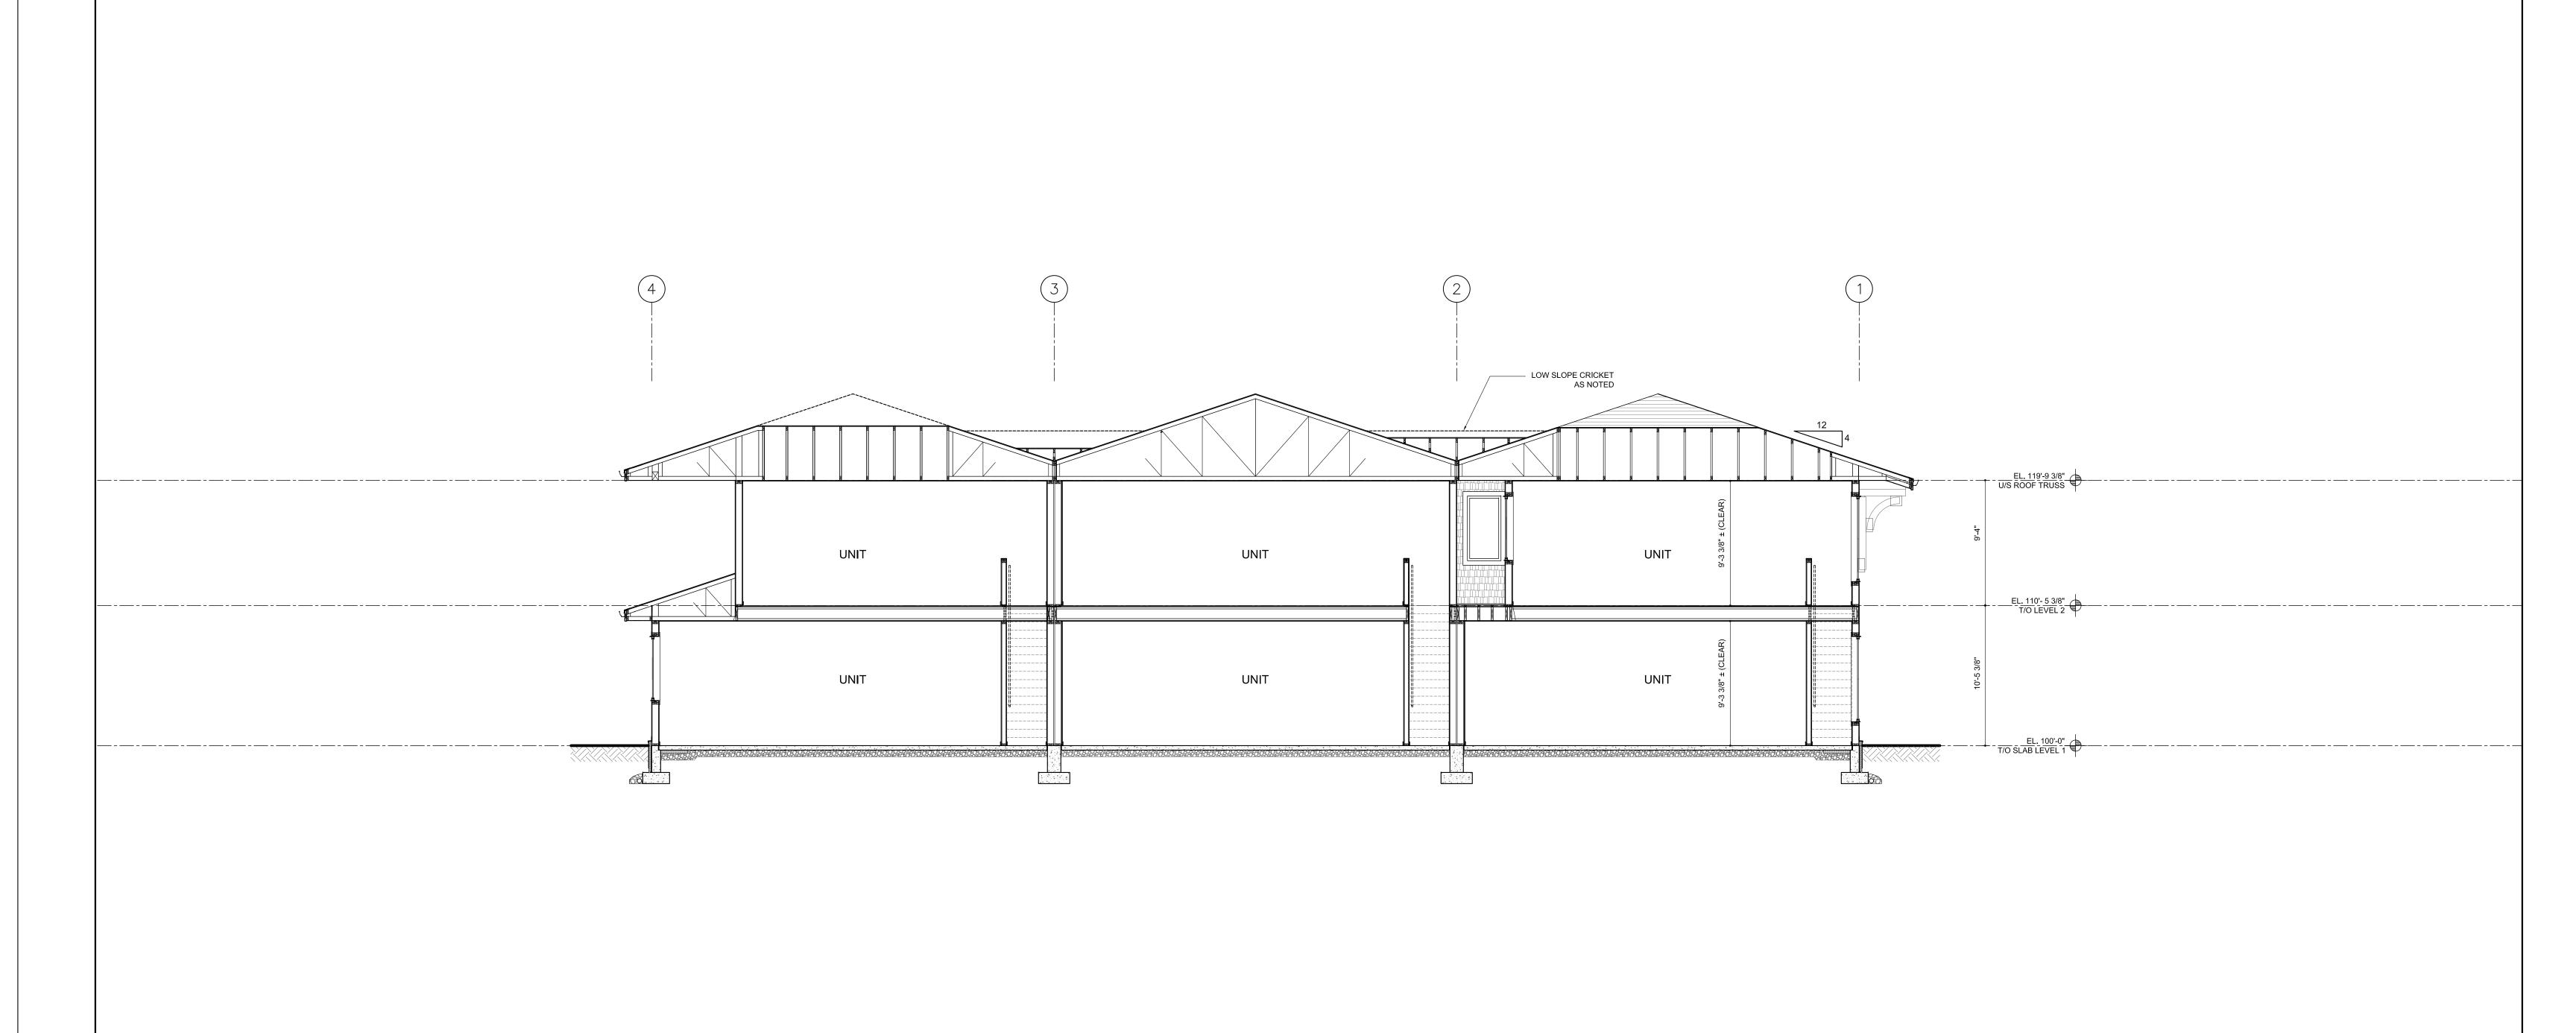
BLDG 4

RANCHER

BLDG. SECTION


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TOWNHOUSES
4500-4680 GALLAGHERS DRIVE EAST



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Drawing Title


BLDG 4

RANCHER

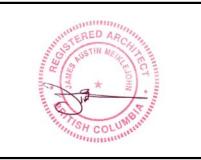
BLDG. SECTION

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GALLAGHERS'S CANYON DEVELOPMENT TOWNHOUSES 4500-4680 GALLAGHERS DRIVE EAST

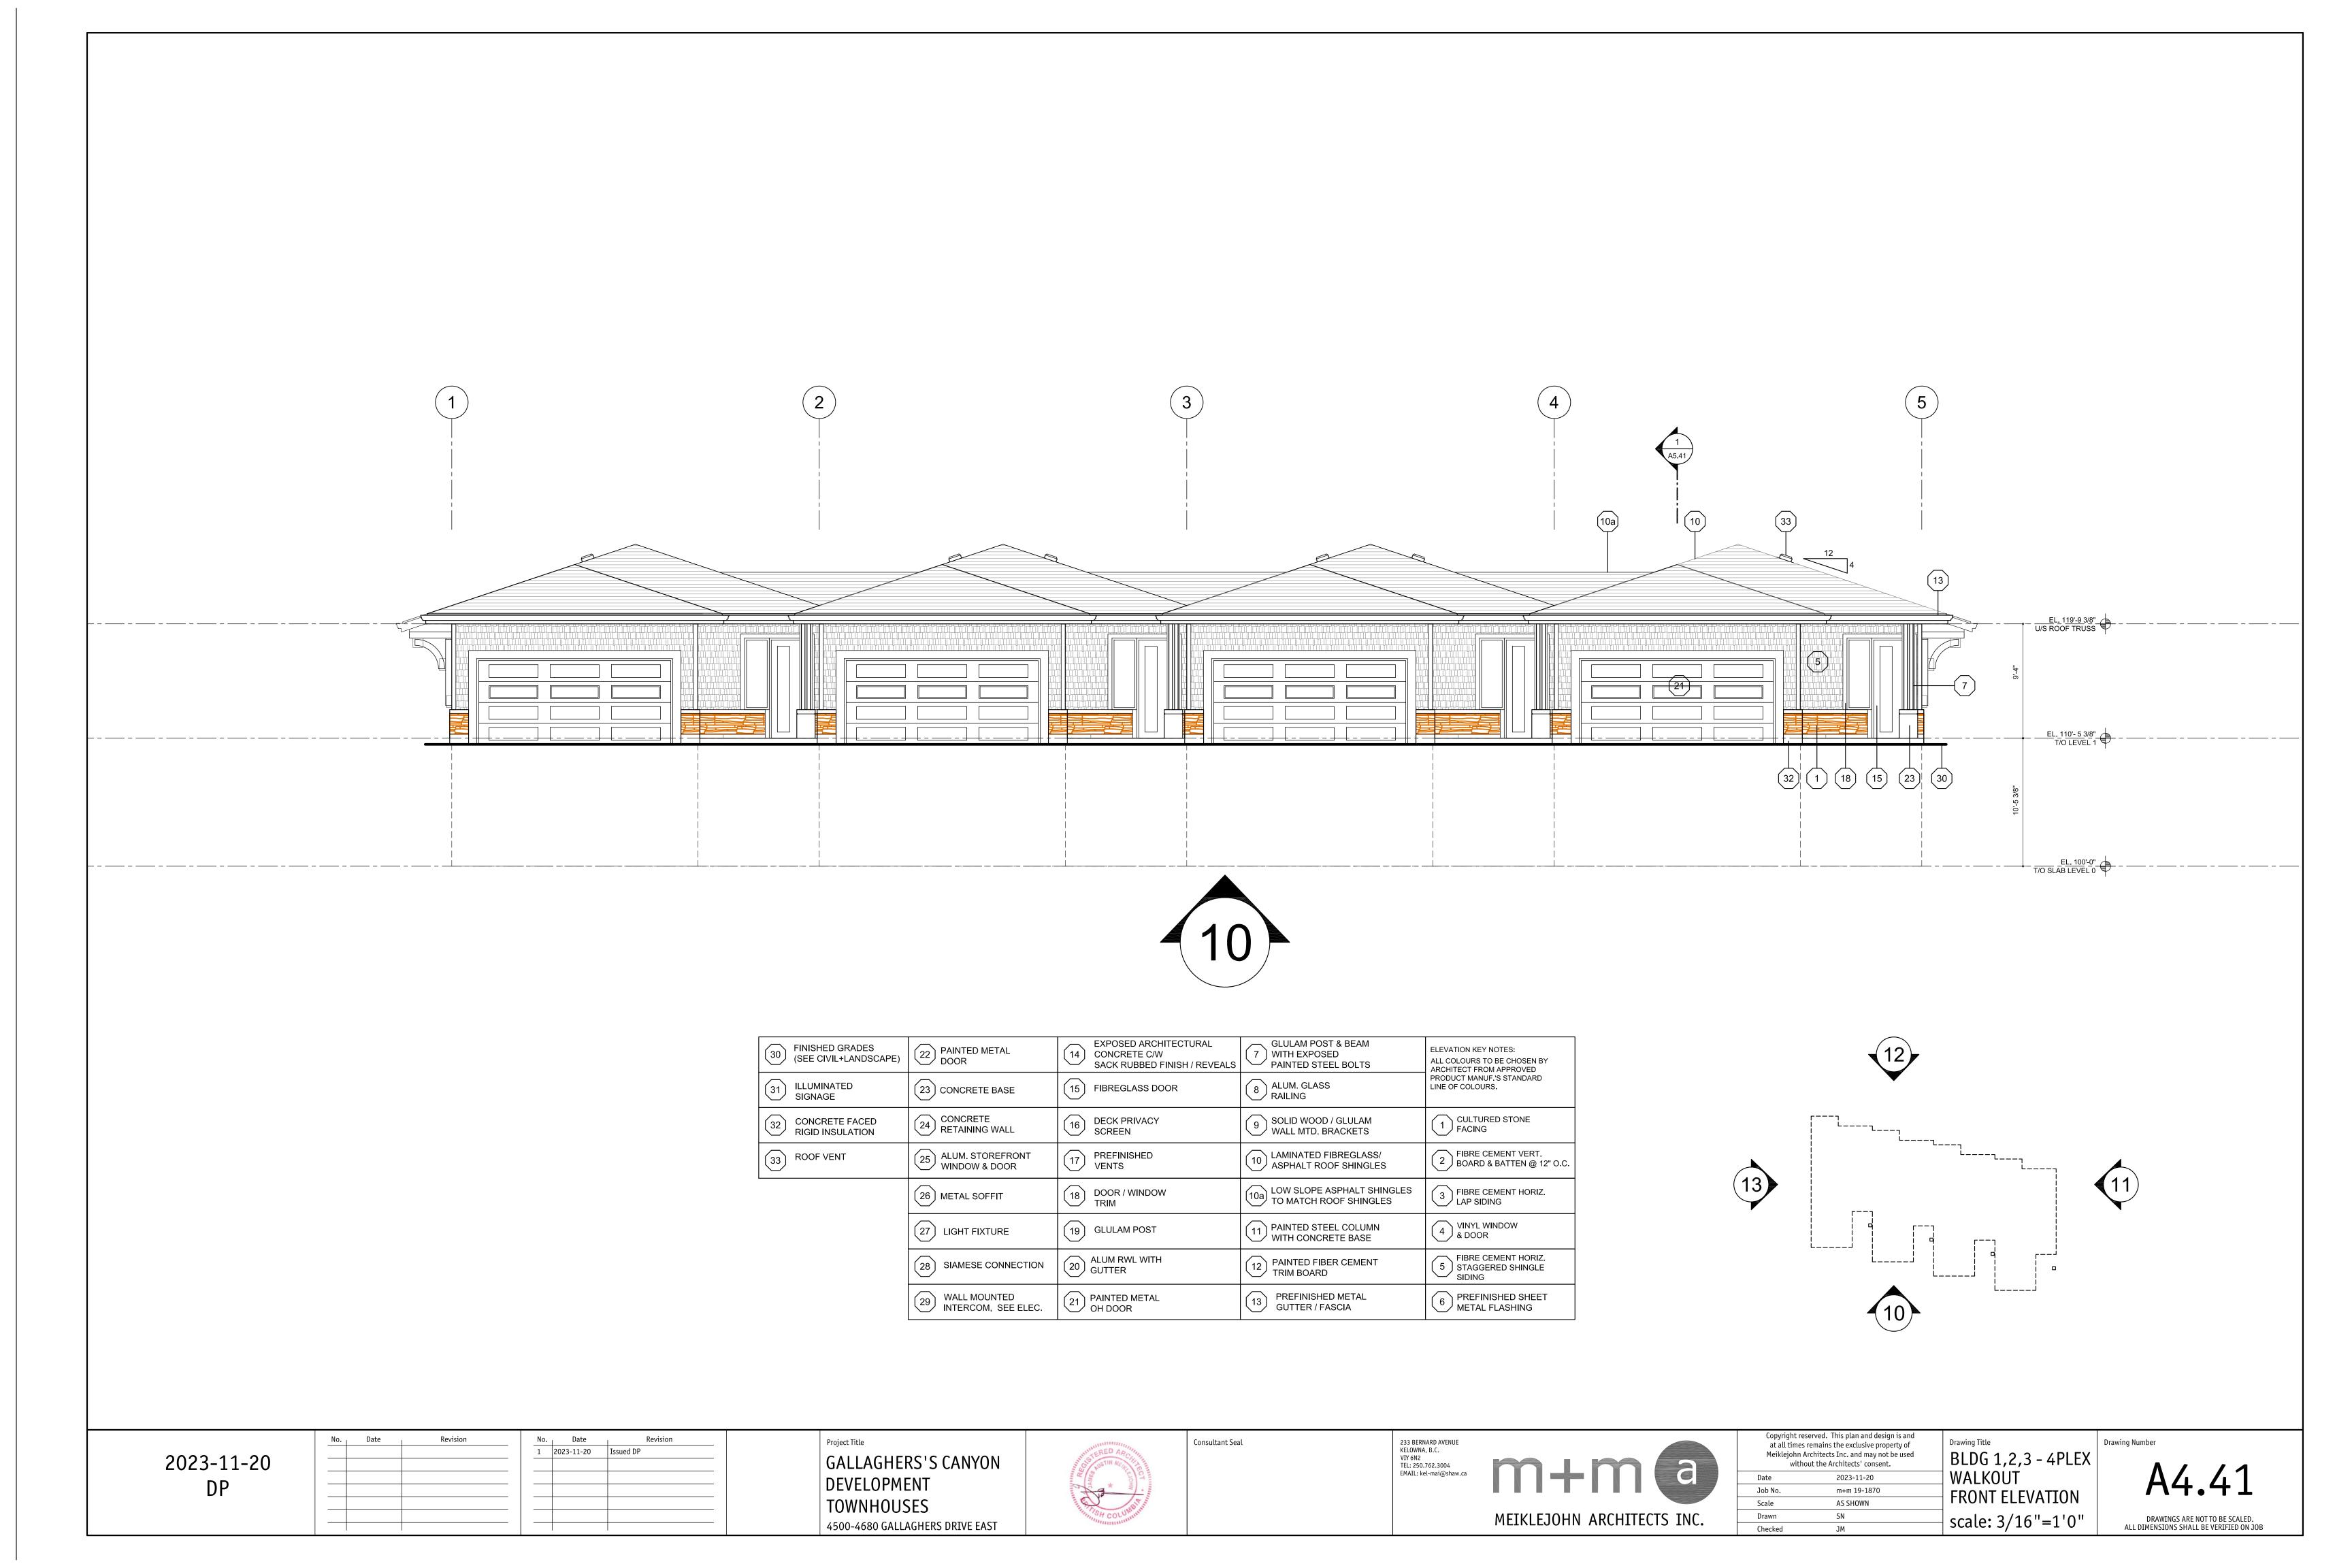

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BLDG 1,2,3 - 4PLEX
WALKOUT
RIGHT ELEVATION | scale: 3/16"=1'0"




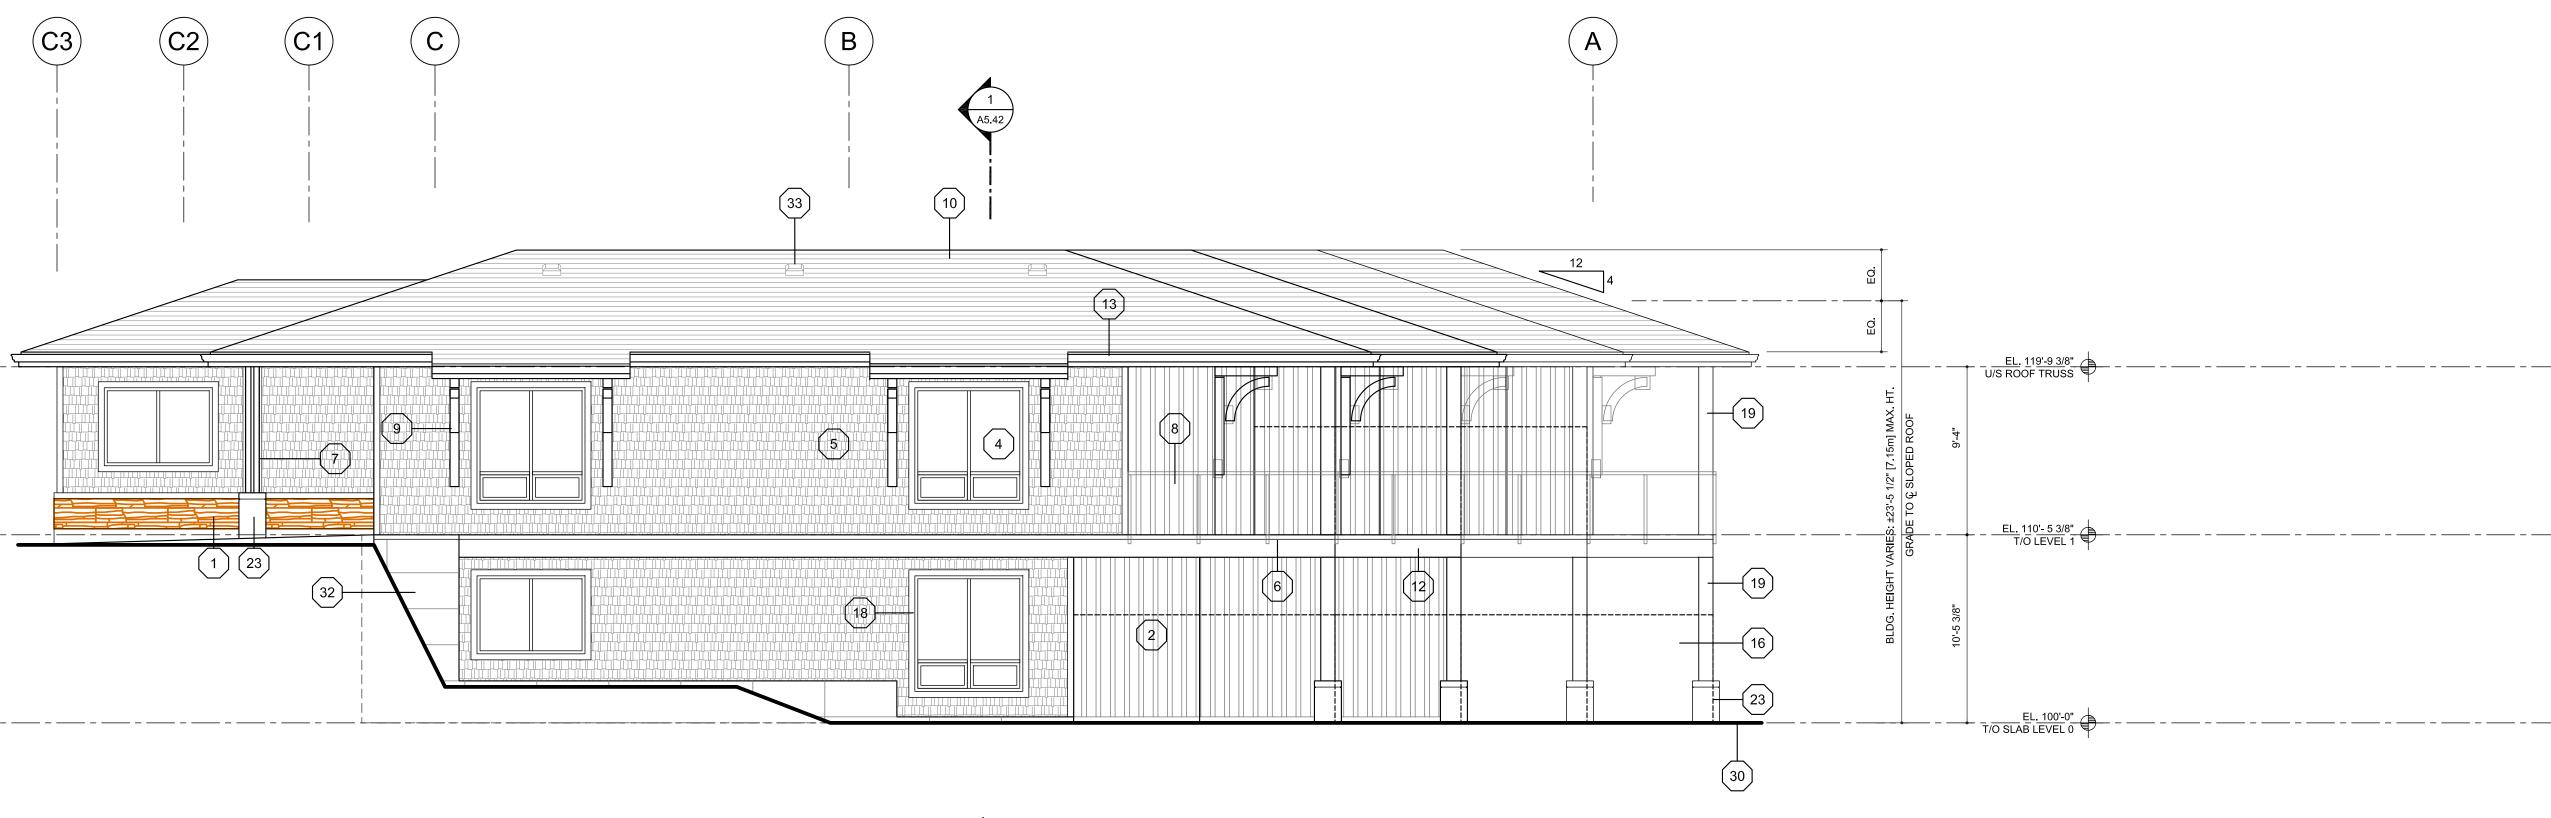

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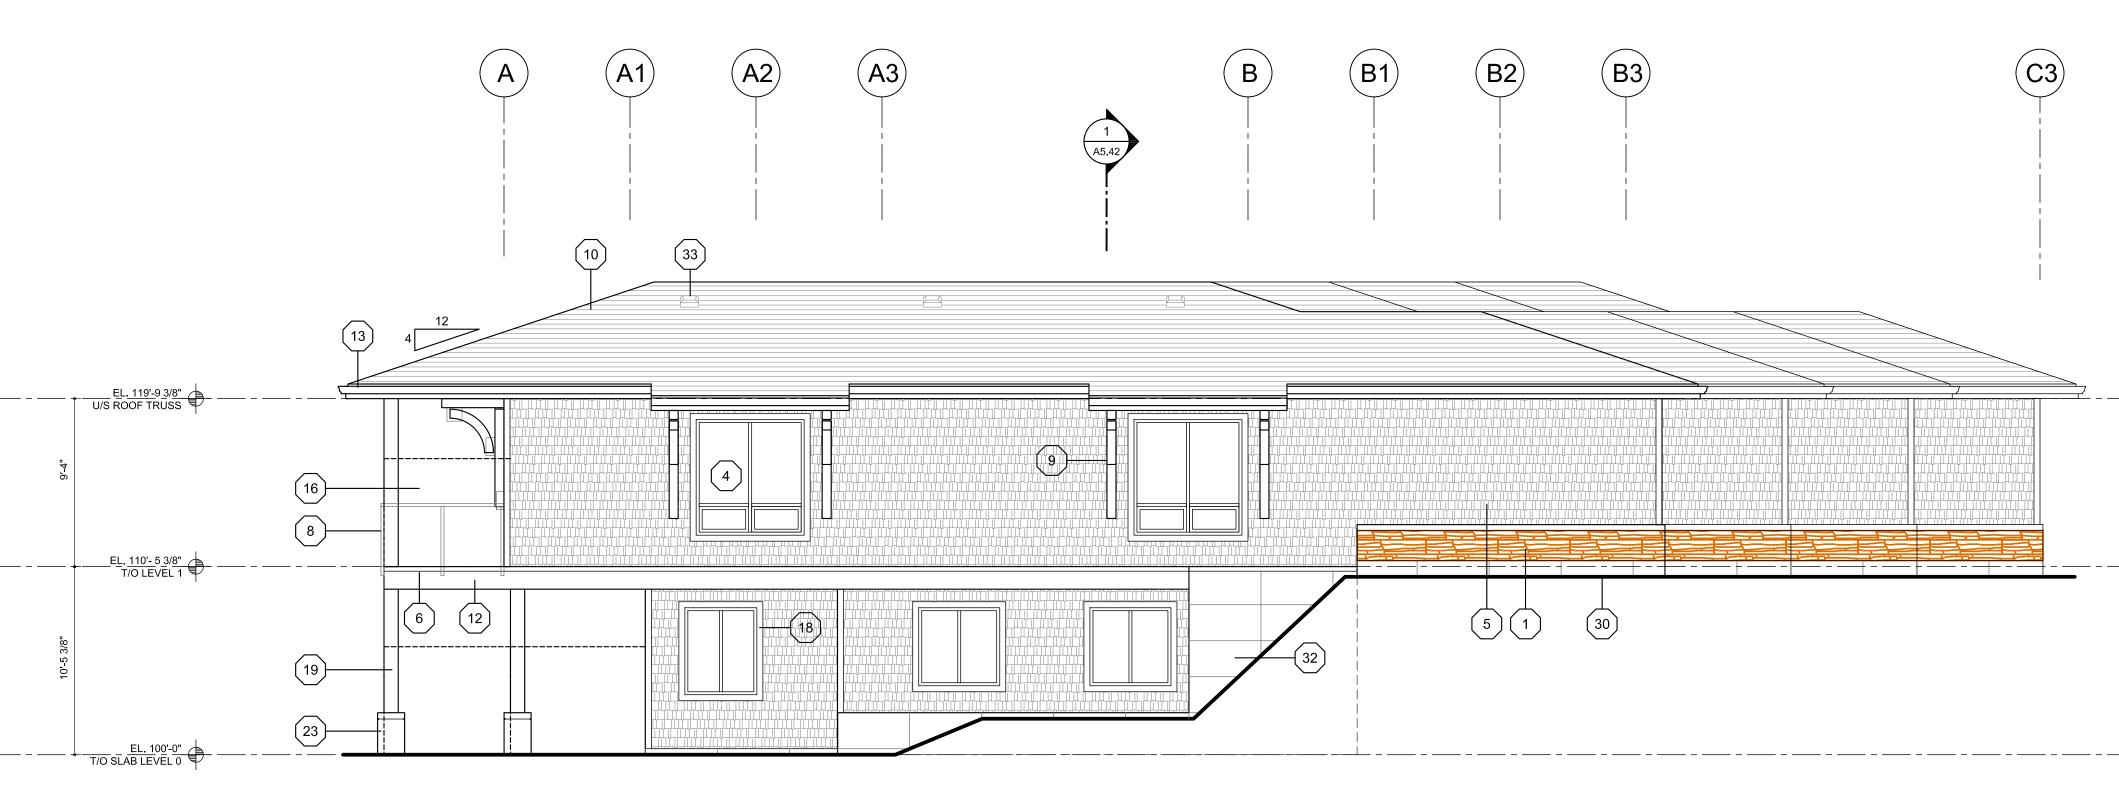



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te	2023-11-20	☐ WALKOUT
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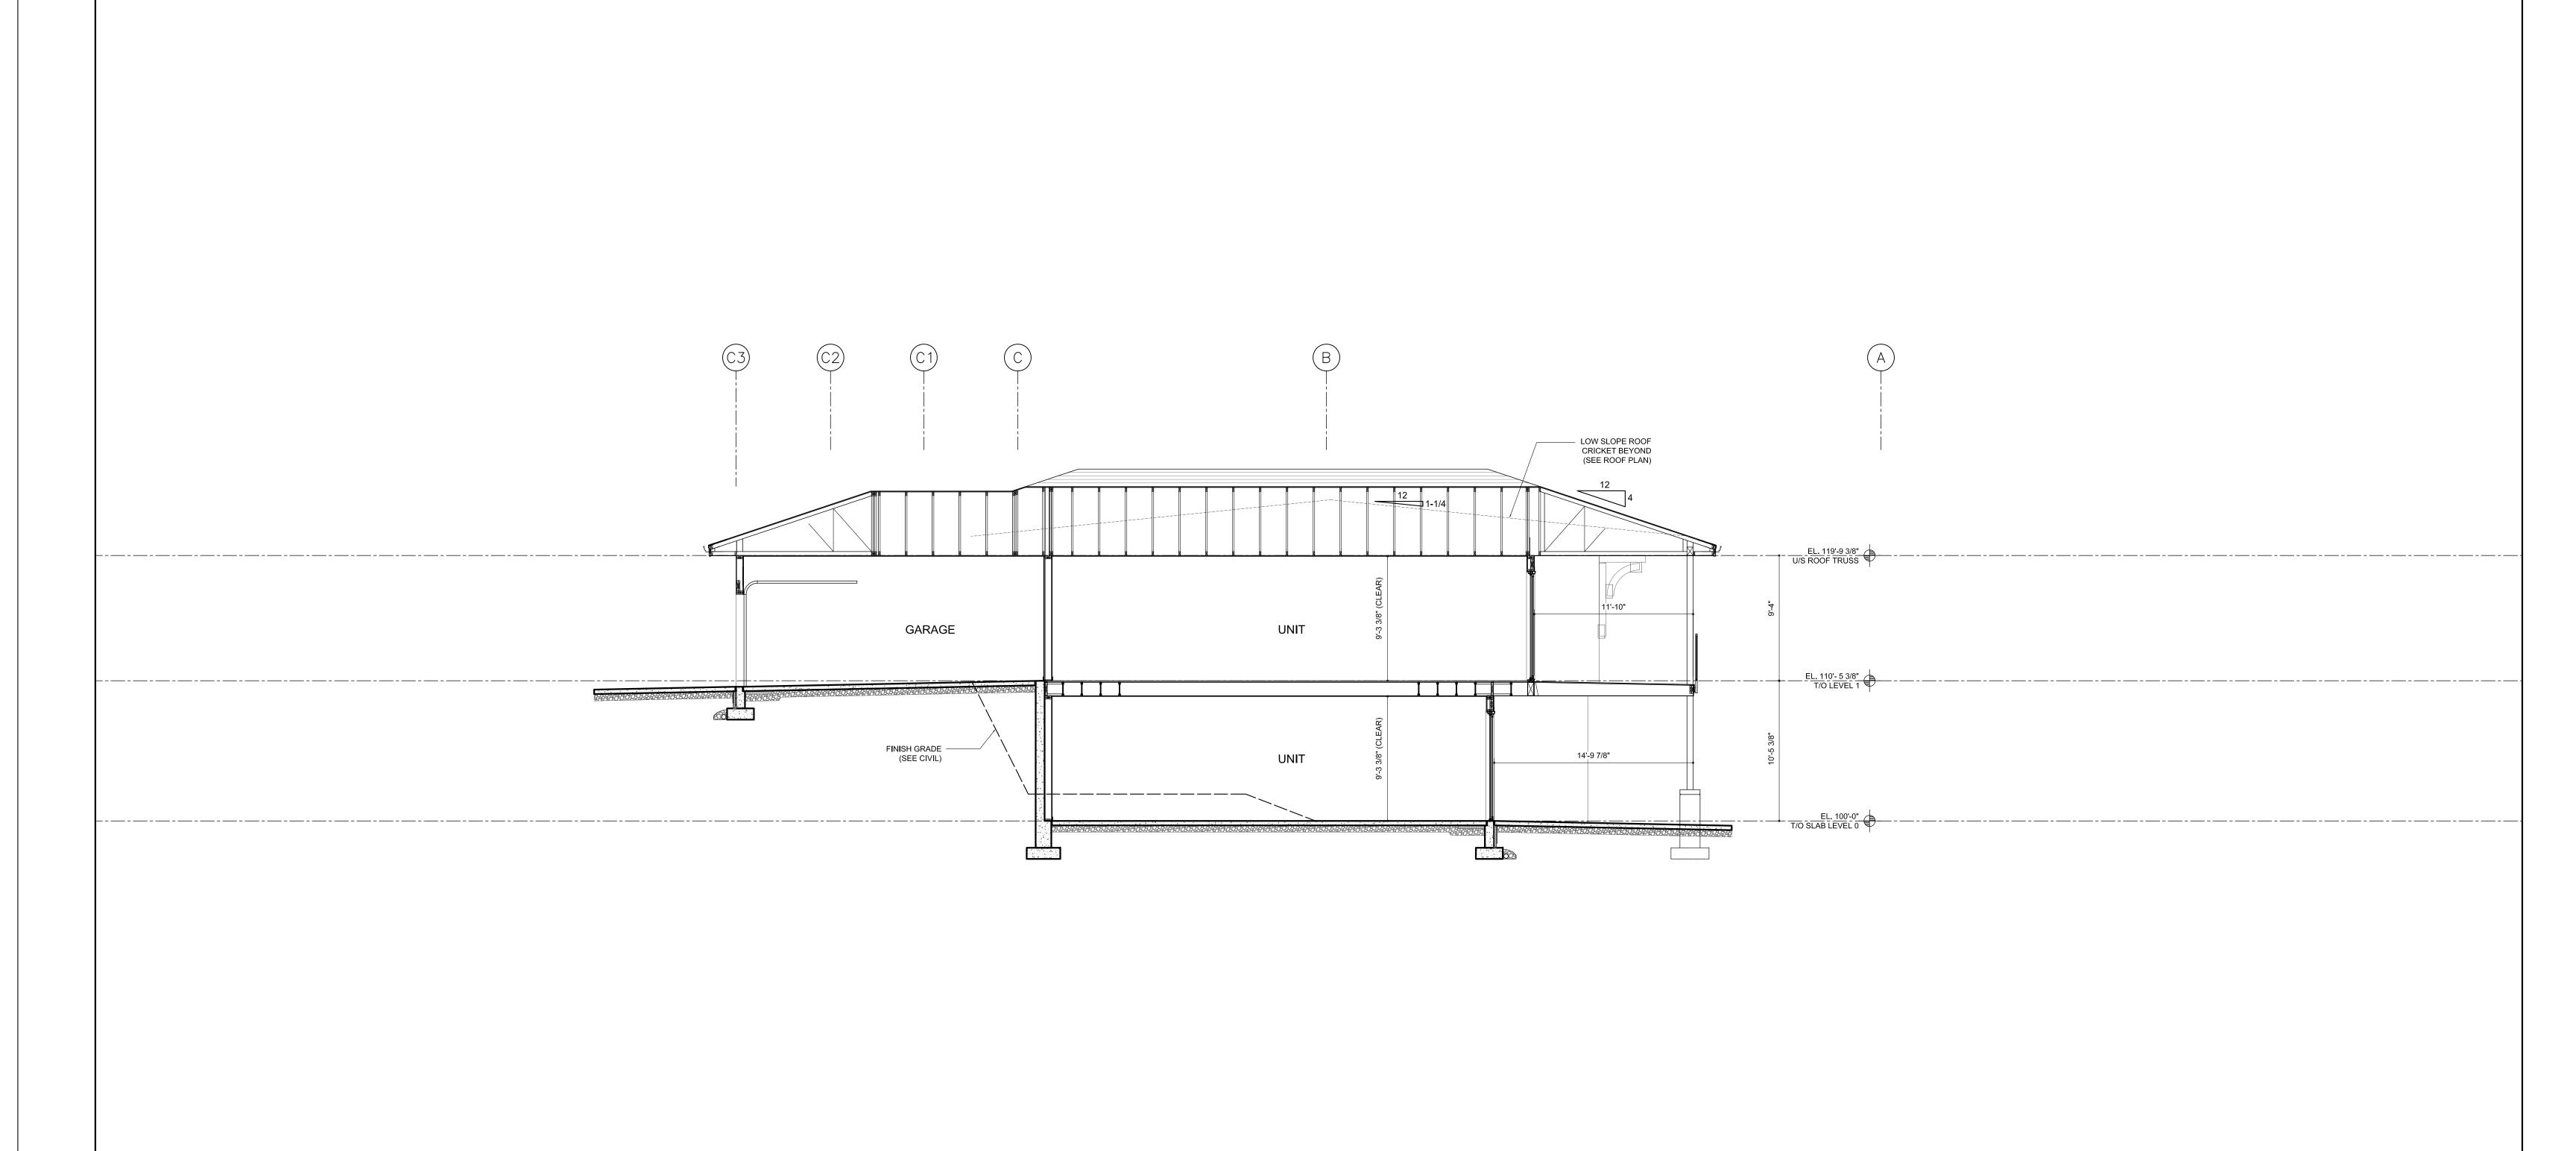


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te	2023-11-20	□ WALKOUT
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GALLAGHERS'S CANYON DEVELOPMENT TOWNHOUSES 4500-4680 GALLAGHERS DRIVE EAST

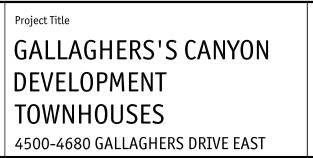


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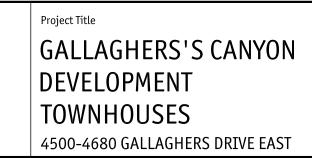
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Date	2023-11-20	WALKOUT
Job No.	m+m 19-1870	
Scale	AS SHOWN	BUILDING SECTION
Drawn	SN	scales 2 /16" 110"
Checked	JM	scale: 3/16"=1'0"

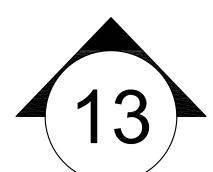

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Date	2023-11-20	□WALKOUT
Job No.	m+m 19-1870	
Scale	AS SHOWN	BUILDING SECTION
Drawn	SN	scales 2 /16 !! 1!0!!
Checked	JM	scale: 3/16"=1'0"

# CRC DEVELOPMENTS
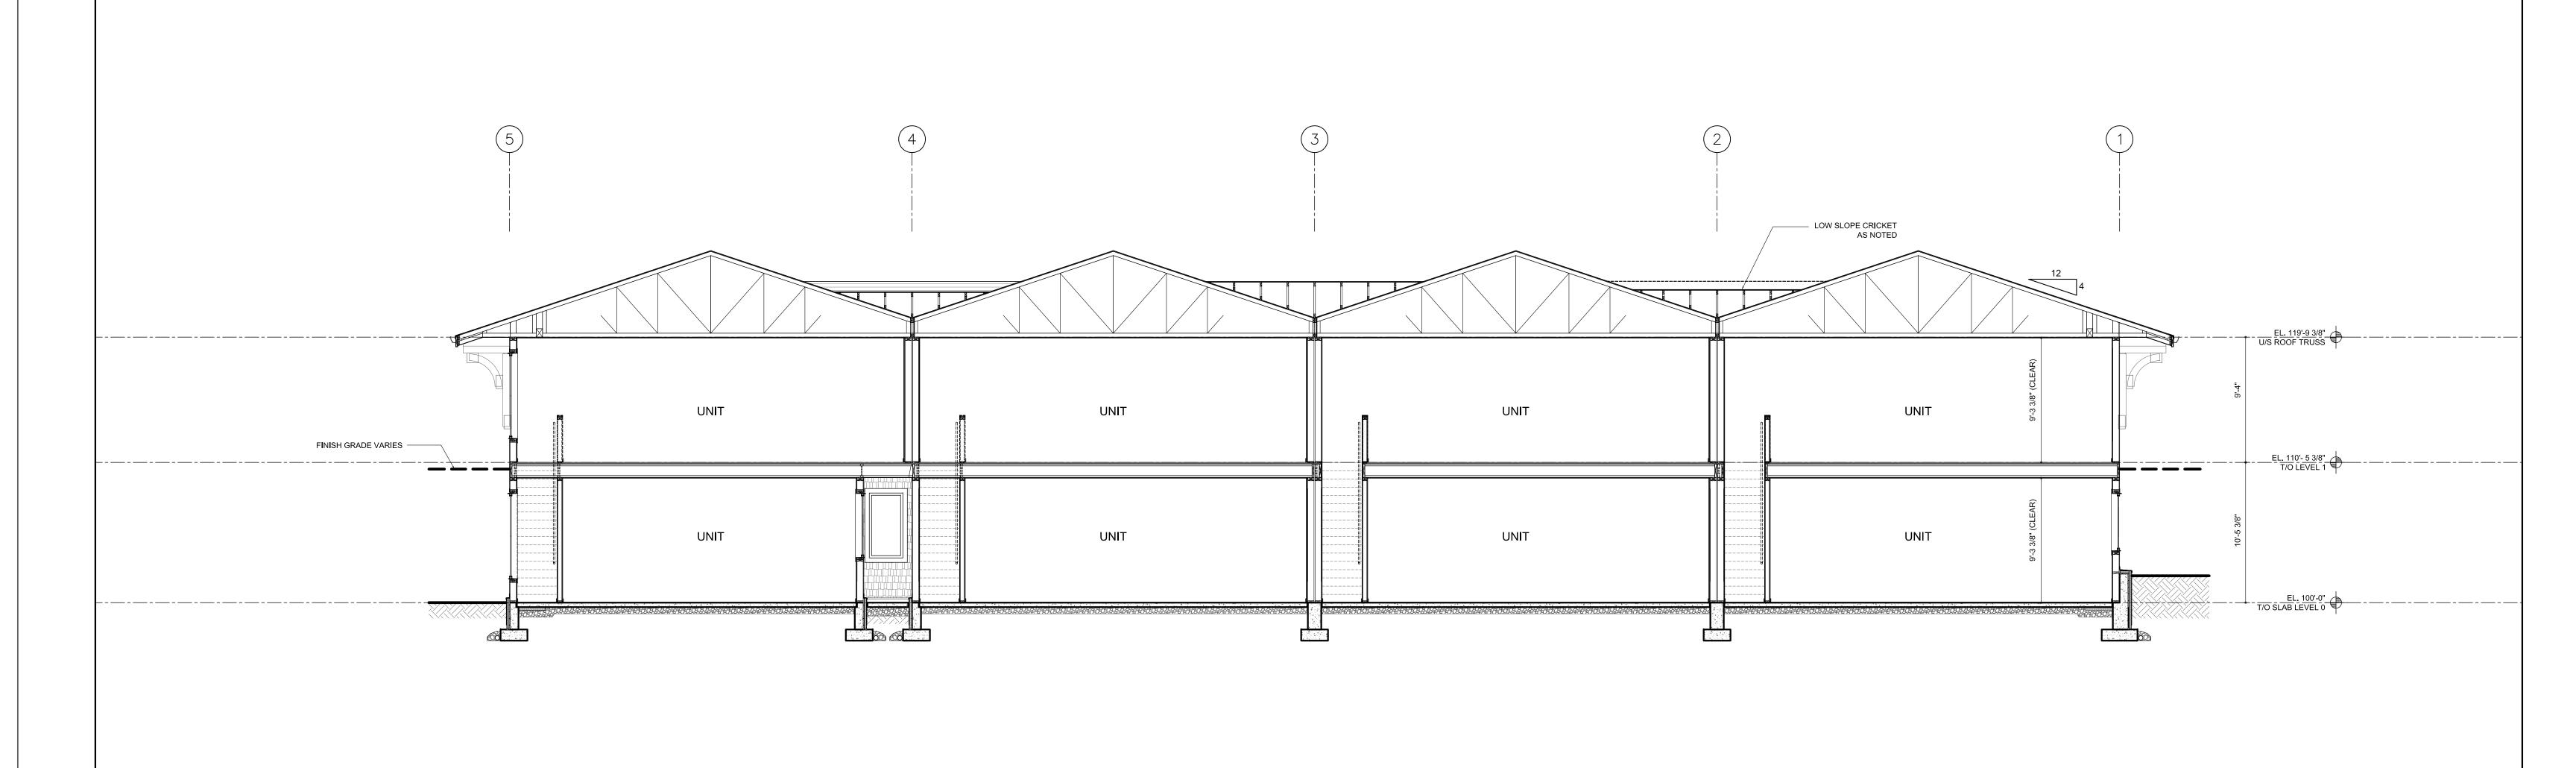
# PINNACLE MULTI-FAMILY DEVELOPMENT

# LANDSCAPE PLAN - RE-ISSUED FOR DEVELOPMENT PERMIT

## **KELOWNA**

NOVEMBER 10, 2023

# TOWNHOUSES MEZ ZONE TOWNHOUSE TOWNHOUSES MEZ ZONE TOWNHOUSES

### LIST OF DRAWINGS

LDP 1: COVER SHEET

LDP 2.1: MF2 TOWNHOUSES - LANDSCAPE PLAN

LDP 2.2: MF3 CONDO - LANDSCAPE PLAN

LDP 3.1: MF2 TOWNHOUSES - HYDROZONE PLAN

LDP 3.2: MF3 CONDO - HYDROZONE PLAN

### JECT NAME: MF2 TOWNHOUSES - PINNACLE MULTI-FAMILY DEVELOPMENT

Landscape Bylaw 12375 (Table 7.2)	Required: MF2 Zone (1 Tree/50m² or 1 Tree/12 lin.m.)	Proposed	Additional	Compliance (Y/N)
Min. tree amount	Landscape sq.m area = 464m <sup>2</sup> /50 = 9 trees (min.) Landscape lin. m setback = 155 l.m/10 = 15 trees (min.)	15 Trees (100% required)	5 Trees	Y
Min. deciduous tree caliper:	Large: 5cm Medium: 4cm Small:3cm	All deciduous trees = 6cm Caliper	All deciduous trees = 6cm Caliper	Y
Min. coniferous tree height:	250cm	N/A	N/A	Y
Min. ratio between tree size:	Large (L): Min. 50% Medium (M): No min. or max. Small (S): Max. 25%	(L) 8 trees = 54% (M) 4 trees = 26% (S) 3 trees = 20%	(L) 0 Trees (M) 4 Trees (S) 1 Trees	Y
Min. growing medium (planted) area	Min. planted area 464m <sup>2</sup> x 75% = 348m2	Total planted area = 464m2	N/A	Υ
Min. growing medium volumes per tree	(L) Tree: Single: 30cu.m Interconnected/trench: 25cu.m (M) Tree: Single: 20cu.m Interconnected/trench: 18cu.m (S) Tree: Single: 15cu.m Interconnected/trench: 12cu.m	(L) Tree: Single: 5 trees/30cu.m per tree Interconnected/trench: 3 trees/25cu.m per tree (M) Tree: Single: 4 tree/20cu.m per tree Interconnected/trench: 0 trees/18cu.m per tree (S) Tree: Single: 0 Interconnected/trench: 3 trees/12cu.m per tree	(L) Tree: N/A (M) Tree: 4m3 per Tree (S) Tree: 4m3 per Tree	Y
Landscape graded areas (7.2.7)	Lawn: 33% max. Shrubs/groundcover: 50% max Cross slope: 2% min.	Lawn: 33% max. Shrubs/groundcover: 50% max Cross slope: 2% min.	Lawn: 33% max. Shrubs/groundcover: 50% max Cross slope: 2% min.	Y
Fence height	2.0m max.	N/A	N/A	Y
Riparian management area (Y/N)	No, development area not within a riparian management zone	No, development area not within a riparian management zone		
Existing tree retention (Y/N)	No			Y
Suface parking lot over 15 stalls (Y/N)	No, on-site parking count less than 15 stalls.			Y
Comments:	Additional medium street trees to enhance frontage of townhouses and cenhance public space.	create sense of uniformity. Additional small garden trees to	enhance common amenity area in centre island to cre	eate shaded areas and

### PROJECT NAME: MF3 CONDO - PINNACLE MULTI-FAMILY DEVELOPMENT

Landscape Bylaw 12375 (Table 7.2)	Required: MF3 Zone (1 Tree/55m <sup>2</sup> or 1 Tree/10 lin.m.)	Proposed	Compliance (Y/N)
Min. tree amount	Landscape sq.m area = 486m <sup>2</sup> /55 = 9 trees (min.) Landscape lin. m setback = 188 l.m/10 = 19 trees (min.)	4 Existing Trees 15 Proposed Trees	Y
Min. deciduous tree caliper:	Large: 5cm Medium: 4cm Small:3cm	All deciduous trees = 6cm Caliper	Y
Min. coniferous tree height:	250cm	N/A	Υ
Min. ratio between tree size:	Large (L): Min. 50% Medium (M): No min. or max. Small (S): Max. 25%	(L) 9 trees = 60% (M) 3 trees = 20% (S) 3 trees = 20%	Y
Min. growing medium (planted) area	Min. growing medium area 486m² x 75% = 365m2	Total growing medium area = 365m <sup>2</sup>	Y
Min. growing medium volumes per tree	(L) Tree: Single: 30cu.m Interconnected/trench: 25cu.m (M) Tree: Single: 20cu.m Interconnected/trench: 18cu.m (S) Tree: Single: 15cu.m Interconnected/trench: 12cu.m	(L) Tree: Single: 2 trees/30cu.m per tree Interconnected/trench: 7 trees/25cu.m per tree (M) Tree: Single: 1 tree/20cu.m per tree Interconnected/trench: 2 trees/18cu.m per tree (S) Tree: Single: 0 Interconnected/trench: 3 trees/12cu.m per tree	Y
Landscape graded areas (7.2.7)	Lawn: 33% max. Shrubs/groundcover: 50% max Cross slope: 2% min.	Lawn: 33% max Shrubs/groundcover: 50% max Cross slope: 2% min.	Y
Fence height	2.0m max.	N/A	Υ
Riparian management area (Y/N)	No, development area not within a riparian management zone		
Existing tree retention (Y/N)	Yes, (4) trees existing to be retained. Tree protection measures to be provided per CoK Stnd. 31 11 41		Υ
Suface parking lot over 15 stalls (Y/N)	No, on-site parking count less than 15 stalls.		
Comments:	(4) existing trees and (15) proposed trees included within the total 19 tree	es to comply with Landscape Bylaw 12375.	





### PLANT LIST - ONSITE - TOWNHOUSES Mature Plant Size SIZE QTY BOTANICAL NAME Trees Deciduous Acer rubrum 'Frank Jr.' 6cm Cal 14 x 10m 11m o/c 8 | Carpinus betulus 'Fastigiata' 6cm Cal B&B 10 x 7m n/a European B | Tilia cordata 'Greenspire' 5cm Cal 20 x 10m n/a | | Syringa reticulata 'Ivory Silk' Amelanchier alnifolia #02 | Potted | 1.2 x 0.9m 0.9m o/c Saskatoon Buxus 'Green Velvet' 0.9m o/c 0.6 x 0.6m 1.5m o/c Cornus stolonifera 'Arctic Fire' 1.2m o/c Mahonia aquifolium Oregon Grape #02 | Potted | 1.4 x 1.5m 1.5m o/c 0.6 x 0.9m Physocarpus opulifolius 1.2 x 1.2m 1.2m o/c lowmound 0.75 x 1m 1 x 1.8m 1.8m o/c Rosa woodsii 'Kimberley' 0.9 x 1.3m 1.3m o/c 1.8 x 1.8m 1.8m o/c Symphoricarpus albus Snowberry Syringa pubescens subsp. patula 'Miss Kim' Taxus x media 'Hicksii' 3 x 1.2m 1.2m o/c Calamagrostis x acutiflora Feather Reed 'Karl Foerster' Deschampsia caespitosa 0.75 x0.75m 0.75m o/c Blue Oat Grass Helictotrichon sempervirens 1 x 0.9m 0.9m o/c Miscanthus sinensis 'Morning Variegated 1.5 x 1m 1m o/c Panicum virgatum 0.9m o/c 1.5 x 0.9m Achillea filipendulina 'Gold 0.9m o/c 1.2 x 0.9m 1.2 x 0.9m upatorium dubium 'Baby Joe 0.6 x 0.6m 0.6m o/c Nepeta x faassenii 'Walker's 0.6 x 0.9m Perovskia atriplicifolia 'Little 0.6m o/c 0.6 x 0.6m Black Eyed 0.6m o/c Rudbeckia fulgida 'Goldstrum' 0.75 x 0.6m

### LEGEND:



( · ) EXISTING TREE TO BE REMOVED

( † ) EXISTING TREE TO BE RETAINED PROPERTY LINE

SETBACK LINE

CONCRETE (BY OTHERS) ASPHALT (BY OTHERS)

COMPACTED GRAVEL PATHWAY PATIO (BY OTHERS)

DECORATIVE ROCK MULCH

ORGANIC BARK MULCH

HYDROSEEDED AREAS EXISTING PLANTING

SHRUB PLANTING

PERENNIAL AND GRASS PLANTING AREA NATIVE POCKET PLANTING

HDR HEADERBOARD

--- ROOTBARRIER

BOULDER

THIS DRAWING TO BE USED FOR DEVELOPMENT PERMIT SUBMISSION ONLY AND IS NOT INTENDED FOR CONSTRUCTION.

THE LANDSCAPE DESIGN INDICATED HEREIN IS CONCEPTUAL; IT DEPICTS FORM AND CHARACTER. REFLECTIVE OF LANDSCAPE DEVELOPMENT REQUIREMENTS FOR Cok BYLAW 12375. ALL PLANT MATERIALS AND CONSTRUCTION

METHODS SHALL CONFORM TO THE MINIMUM STANDARDS SET OUT IN THE CANADIAN LANDSCAPE STANDARD (CURRENT EDITION). PLANT MATERIAL SELECTIONS INDICATED HEREIN ARE CONCEPTUAL ONLY. FINAL PLANTING SELECTIONS MAY VARY DEPENDING UPON

AVAILABILITY. ALL PLANTING BEDS SHALL HAVE AN APPROVED

ALL LANDSCAPE AREAS ARE TO BE IRRIGATED WITH A HIGH-EFFICIENCY UNDERGROUND AUTOMATIC IRRIGATION SYSTEM.

### PRECEDENT IMAGES:

Allium sphaerocephalon





3 bulbs per 1.5m2

















2023-11-10







PINNACLE MULTI-FAMILY DEVELOPMENT

CRC DEVELOPMENTS





)	NO.	DESCRIPTION	
	0	RE-ISSUED FOR DEVELOPMENT PERMIT	
		ISSUED FOR:	

LANDSCAPE PLAN - ON SITE -MF2 TOWNHOUSES **LDP 2.1** 



QTY	BOTANICAL NAME	COMMON NAME	SIZE	ROOT	Mature Plant Size (Ht.xWd.)	SPACING
	Trees Deciduous					
4	Acer rubrum 'Frank Jr.'	Redpointe Maple	6cm Cal	B&B	14 x 10m	8m o/c
3	Acer palmatum 'Bloodgood'	Bloodgood Japanese Maple	6cm Cal	B&B	6 x 6m	n/a
3	Carpinus betulus 'Fastigiata'	Pyramidal European Hornbeam	6cm Cal	B&B	10 x 7m	9.5m o/c
1	Gingko biloba	Maidenhair Tree	6cm Cal	B&B	15 x 10m	n/a
4	Tilia cordata 'Greenspire'	Greenspire Linden	6cm Cal	B&B	20 x 10m	9m o/c
	Shrubs					
	Amelanchier alnifolia	Saskatoon	#02	Potted	1.2 x 0.9m	0.9m o/c
	Buxus 'Green Velvet'	Green Velvet Boxwood	#02	Potted	1.2 x 0.9m	0.9m o/c
	Cornus stolonifera 'Arctic Fire'	Red Osier Dogwood	#02	Potted	1.2 x 1.2m	1.2m o/c
	Mahonia aquifolium	Oregon Grape	#02	Potted	1.4 x 1.5m	1.5m o/c
	Physocarpus opulifolius 'Dart's Gold'	Common Ninebark	#02	Potted	1.2 x 1.2m	1.2m o/c
	Rhus aromatica 'Gro-Low'	Fragrant Sumac	#02	Potted	1 x 1.8m	1.8m o/c
	Rosa woodsii 'Kimberley'	Kimberley Wild Rose	#02	Potted	0.9 x 1.3m	1.3m o/c
	Symphoricarpus albus	Snowberry	#02	Potted	1.8 x 1.8m	1.8m o/c
	Syringa pubescens subsp. patula 'Miss Kim'	Dwarf Korean Lilac	#02	Potted	1.8 x 1.8m	1.8m o/c
	Ornamental Grasses					
	Calamagrostis x acutiflora 'Karl Foerster'	Feather Reed Grass	#01	Potted	1.5 x 1.2m	1.2m o/c
	Deschampsia caespitosa 'Goldtau'	Gold Dew Tufted Hair Grass	#01	Potted	0.75 x0.75m	0.75m o/
	Perennials					
	Achillea filipendulina 'Gold Plate'	'Gold Plate' Yarrow	#01	Potted	1.2 x 0.9m	0.9m o/c
	Aster frikartii 'Monch'	Frikart's Aster	#01	Potted	1.2 x 0.9m	0.9m o/c
	Eupatorium dubium 'Baby Joe'	Dwarf Joe Pye Weed	#01	Potted	0.6 x 0.6m	0.6m o/c
	Nepeta x faassenii 'Walker's Low'	Walker's Low Catmint	#01	Potted	0.6 x 0.9m	0.9m o/c
	Perovskia atriplicifolia 'Little Spire'	Little Spire Russian Sage	#01	Potted	0.6 x 0.6m	0.6m o/c
	Rudbeckia fulgida 'Goldstrum'	Black Eyed Susan	#01	Potted	0.75 x 0.6m	0.6m o/c

### PRECEDENT IMAGES:













LEGEND:

PROPOSED TREE

CONCRETE (BY OTHERS)

ASPHALT (BY OTHERS)

DECORATIVE ROCK MULCH

ORGANIC BARK MULCH

HYDROSEEDED AREAS

NATIVE POCKET PLANTING

1. THIS DRAWING TO BE USED FOR DEVELOPMENT

2. THE LANDSCAPE DESIGN INDICATED HEREIN IS

REQUIREMENTS FOR Cok BYLAW 12375.

3. ALL PLANT MATERIALS AND CONSTRUCTION

STANDARD (CURRENT EDITION).

REFLECTIVE OF LANDSCAPE DEVELOPMENT

4. PLANT MATERIAL SELECTIONS INDICATED HEREIN

ARE CONCEPTUAL ONLY. FINAL PLANTING

SELECTIONS MAY VARY DEPENDING UPON

ALL PLANTING BEDS SHALL HAVE AN APPROVED

ALL LANDSCAPE AREAS ARE TO BE IRRIGATED WITH

A HIGH-EFFICIENCY UNDERGROUND AUTOMATIC

PERMIT SUBMISSION ONLY AND IS NOT INTENDED

CONCEPTUAL; IT DEPICTS FORM AND CHARACTER.

METHODS SHALL CONFORM TO THE MINIMUM

STANDARDS SET OUT IN THE CANADIAN LANDSCAPE

EXISTING PLANTING

SHRUB PLANTING

HDR HEADERBOARD

--- ROOTBARRIER

EXISTING SOD

SOD PLANTING

BOULDER

FOR CONSTRUCTION.

AVAILABILITY.

IRRIGATION SYSTEM.

PATIO (BY OTHERS)

PROPERTY LINE

\_ \_ SETBACK LINE

( · ) EXISTING TREE TO BE REMOVED

( † ) EXISTING TREE TO BE RETAINED

COMPACTED GRAVEL PATHWAY

PERENNIAL AND GRASS PLANTING AREA









	ISSUED FOR:	
	RE-ISSUED FOR	
0	DEVELOPMENT PERMIT	2023-11-10
NO.	DESCRIPTION	DATE

LANDSCAPE PLAN - ON SITE -MF3 CONDOS


**LDP 2.2** 

PINNACLE MULTI-FAMILY DEVELOPMENT **CRC DEVELOPMENTS** 





# PINNACLE MULTI-FAMILY DEVELOPMENT CRC DEVELOPMENTS

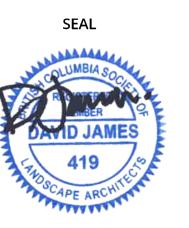


NOR	тн
SCALE :	1:30

	ISSUED FOR:			
0	RE-ISSUED FOR DEVELOPMENT PERMIT	2023-11-06		
NO.	DESCRIPTION	DATE		

MF2 TOWNHOUSES HYDROZONE PLAN


LDP 3.1

OJECT NO. : 21157 DATE :2021-12-21

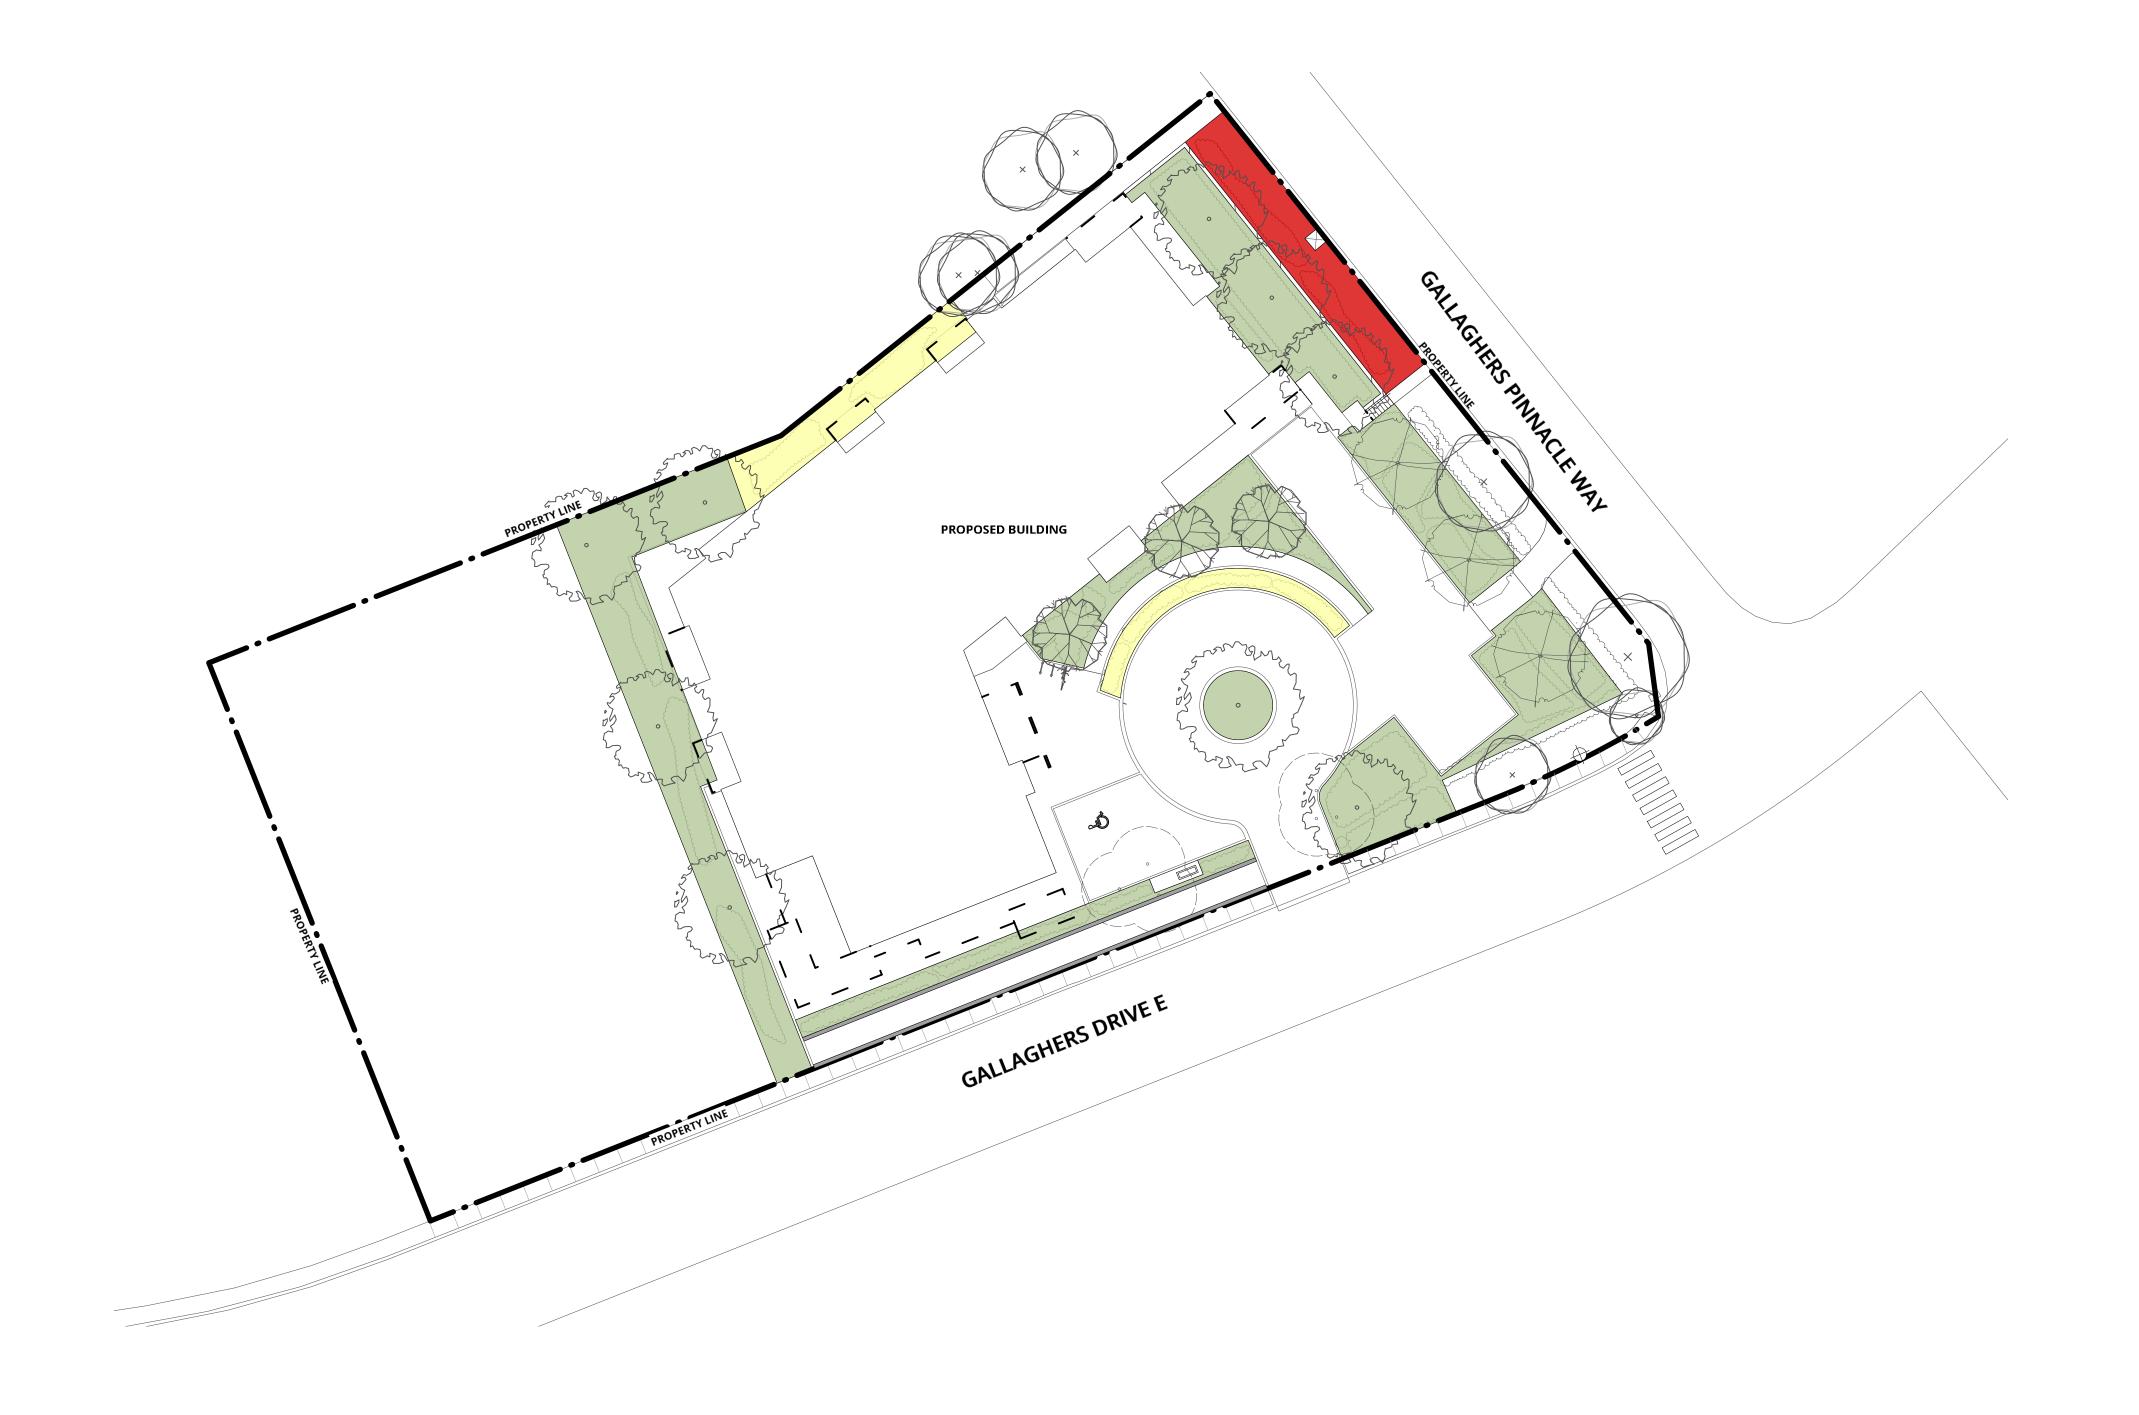



# PINNACLE MULTI-FAMILY DEVELOPMENT CRC DEVELOPMENTS

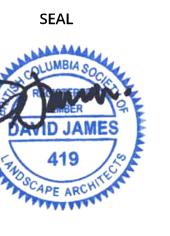



ISSUED FOR:			
0	RE-ISSUED FOR DEVELOPMENT PERMIT	2023-11-06	
NO.	DESCRIPTION	DATE	

MF3 CONDO - HYDROZONE PLAN

**LDP 3.2** 

FCT NO · 21157 DATE · 2021-12.

PRELIMINARY SUBDIVISION PLAN OF PARTS OF LOT A AND AN UNDIVIDED 1/24th SHARE IN LOT G PLAN KAP53116 SECTIONS 1 AND 12 TOWNSHIP 26 ODYD PLAN KAP66064

BCGS 82E.084

5 0 10 25 50

THE INTENDED PLOT SIZE OF THIS PLAN IS 864mm IN WIDTH BY 560mm IN HEIGHT (D SIZE) WHEN PLOTTED AT A SCALE OF 1:600

### \*PRELIMINARY\*

DATE: NOVEMBER 22, 2023

CLIENT: CRC CANADIAN RETIREMENT CORP.

NOTE: ACCESS TO LOT 1 WILL BE THROUGH COMMON LOT G, PLAN KAP53116 PURSUANT TO BC REGULATION 334/79. LOT 1 WILL DERIVE A 1/72 SHARE IN COMMON LOT G, PLAN KAP53116.

NOTE: ACCESS TO LOT 2 WILL BE THROUGH COMMON LOT G, PLAN KAP53116 PURSUANT TO BC REGULATION 334/79. LOT 2 WILL DERIVE A 1/72 SHARE IN COMMON LOT G, PLAN KAP53116.

NOTE: LOT AREAS AND DIMENSIONS ARE SUBJECT TO FINAL LEGAL SURVEY.

### \*PRELIMINARY\*

### LEGEND

INTEGRATED SURVEY AREA NO. 4, CITY OF KELOWNA, NAD83 (CSRS) 4.0.0.BC.1

GRID BEARINGS ARE DERIVED FROM OBSERVATIONS BETWEEN GEODETIC CONTROL MONUMENTS [LIST CONTROL MONUMENTS] AND ARE REFERRED TO THE CENTRAL MERIDIAN OF UTM ZONE 11.

THE UTM COORDINATES AND ESTIMATED ABSOLUTE ACCURACY ACHIEVED ARE DERIVED FROM MASCOT PUBLISHED COORDINATES AND STANDARD DEVIATIONS FOR GEODETIC CONTROL MONUMENTS [LIST CONTROL MONUMENTS].

THIS PLAN SHOWS HORIZONTAL GROUND-LEVEL DISTANCES UNLESS OTHERWISE SPECIFIED. TO COMPUTE GRID DISTANCES, MULTIPLY GROUND-LEVEL DISTANCES BY THE AVERAGE COMBINED FACTOR OF 0.9999 WHICH HAS BEEN DERIVED FROM GEODETIC CONTROL MONUMENTS [LIST CONTROL MONUMENTS].

THIS PLAN LIES WITHIN THE REGIONAL DISTRICT OF CENTRAL OKANAGAN.

ACCESS BY COMMON LOT.

THIS PLAN LIES WITHIN THE JURISDICTION OF THE APPROVING OFFICER FOR THE CITY OF KELOWNA.

THE FIELD SURVEY REPRESENTED BY THIS PLAN WAS COMPLETED ON THE xx DAY OF xxxxx, 202x CAMERON HENRY, BCLS 857

Ferguson Land Surveying & Geomatics Ltd.

B.C. AND CANADA LAND SURVEYORS

404-1630 PANDOSY STREET, KELOWNA, B.C.

TELEPHONE (250) 763-3115 FAX (250) 763-0321

JOB No 21605-SUB

